
# CEDAR LANE DRAINAGE IMPROVEMENTS

# FOR

# CITY OF GREENVILLE GREENVILLE, NORTH CAROLINA

HAZEN NO.: 31187-003

# JANUARY 2022

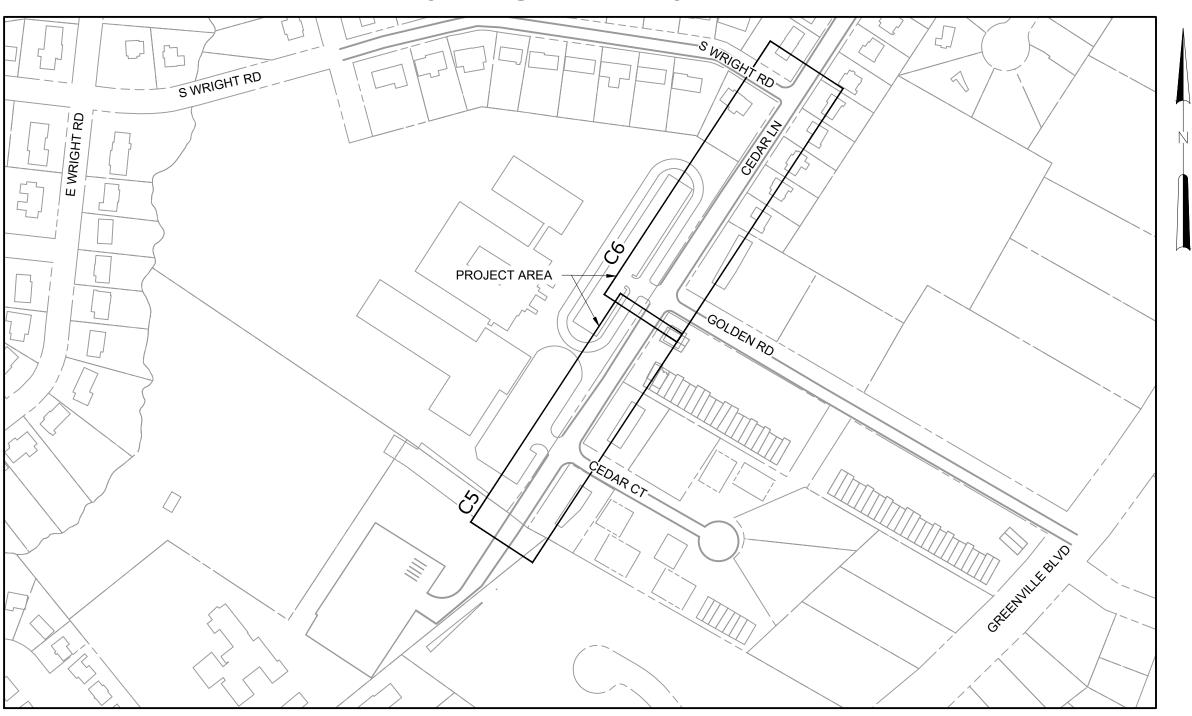


LOCATION MAP 1" = 200'

		PRO.	JECT CONTACTS		
	CITY OF GREENVILLE		HAZEN AND SAWYER		COOPER AND ASSOCIATES SURVEYORS, P.A.
	LISA KIRBY, PE		CORINNE E. WILSON, PE		
OWNER	1500 BEATTY ST	ENGINEER	4011 WESTCHASE BLVD, SUITE 500	SURVEYOR	404 E. CHATHAM ST, SUITE E
	GREENVILLE, NC 27834		RALEIGH, NC 27607		CARY, NC 27511
	(252) 329 - 4683		(919) 863 - 9257		(919) 469 - 1760
	LKIRBY@GREENVILLENC.GOV		CDWILSON@HAZENANDSAWYER.COM		



LICENSE NO.: C-0381


HAZEN AND SAWYER
4011 WESTCHASE BOULEVARD, SUITE 500
RALEIGH, NORTH CAROLINA 27607

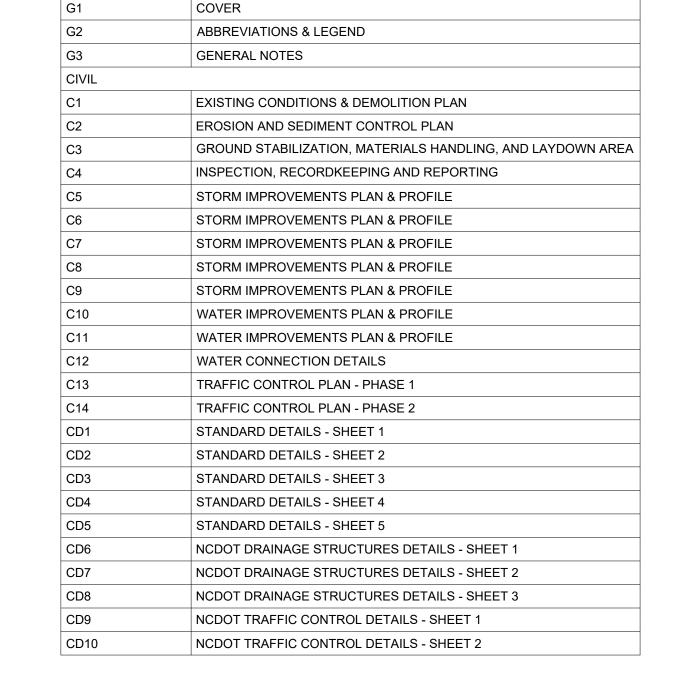

DRAWING LIST

DRAWING NUMBER | DRAWING TITLE

FINAL DESIGN - DO NOT USE FOR CONSTRUCTION

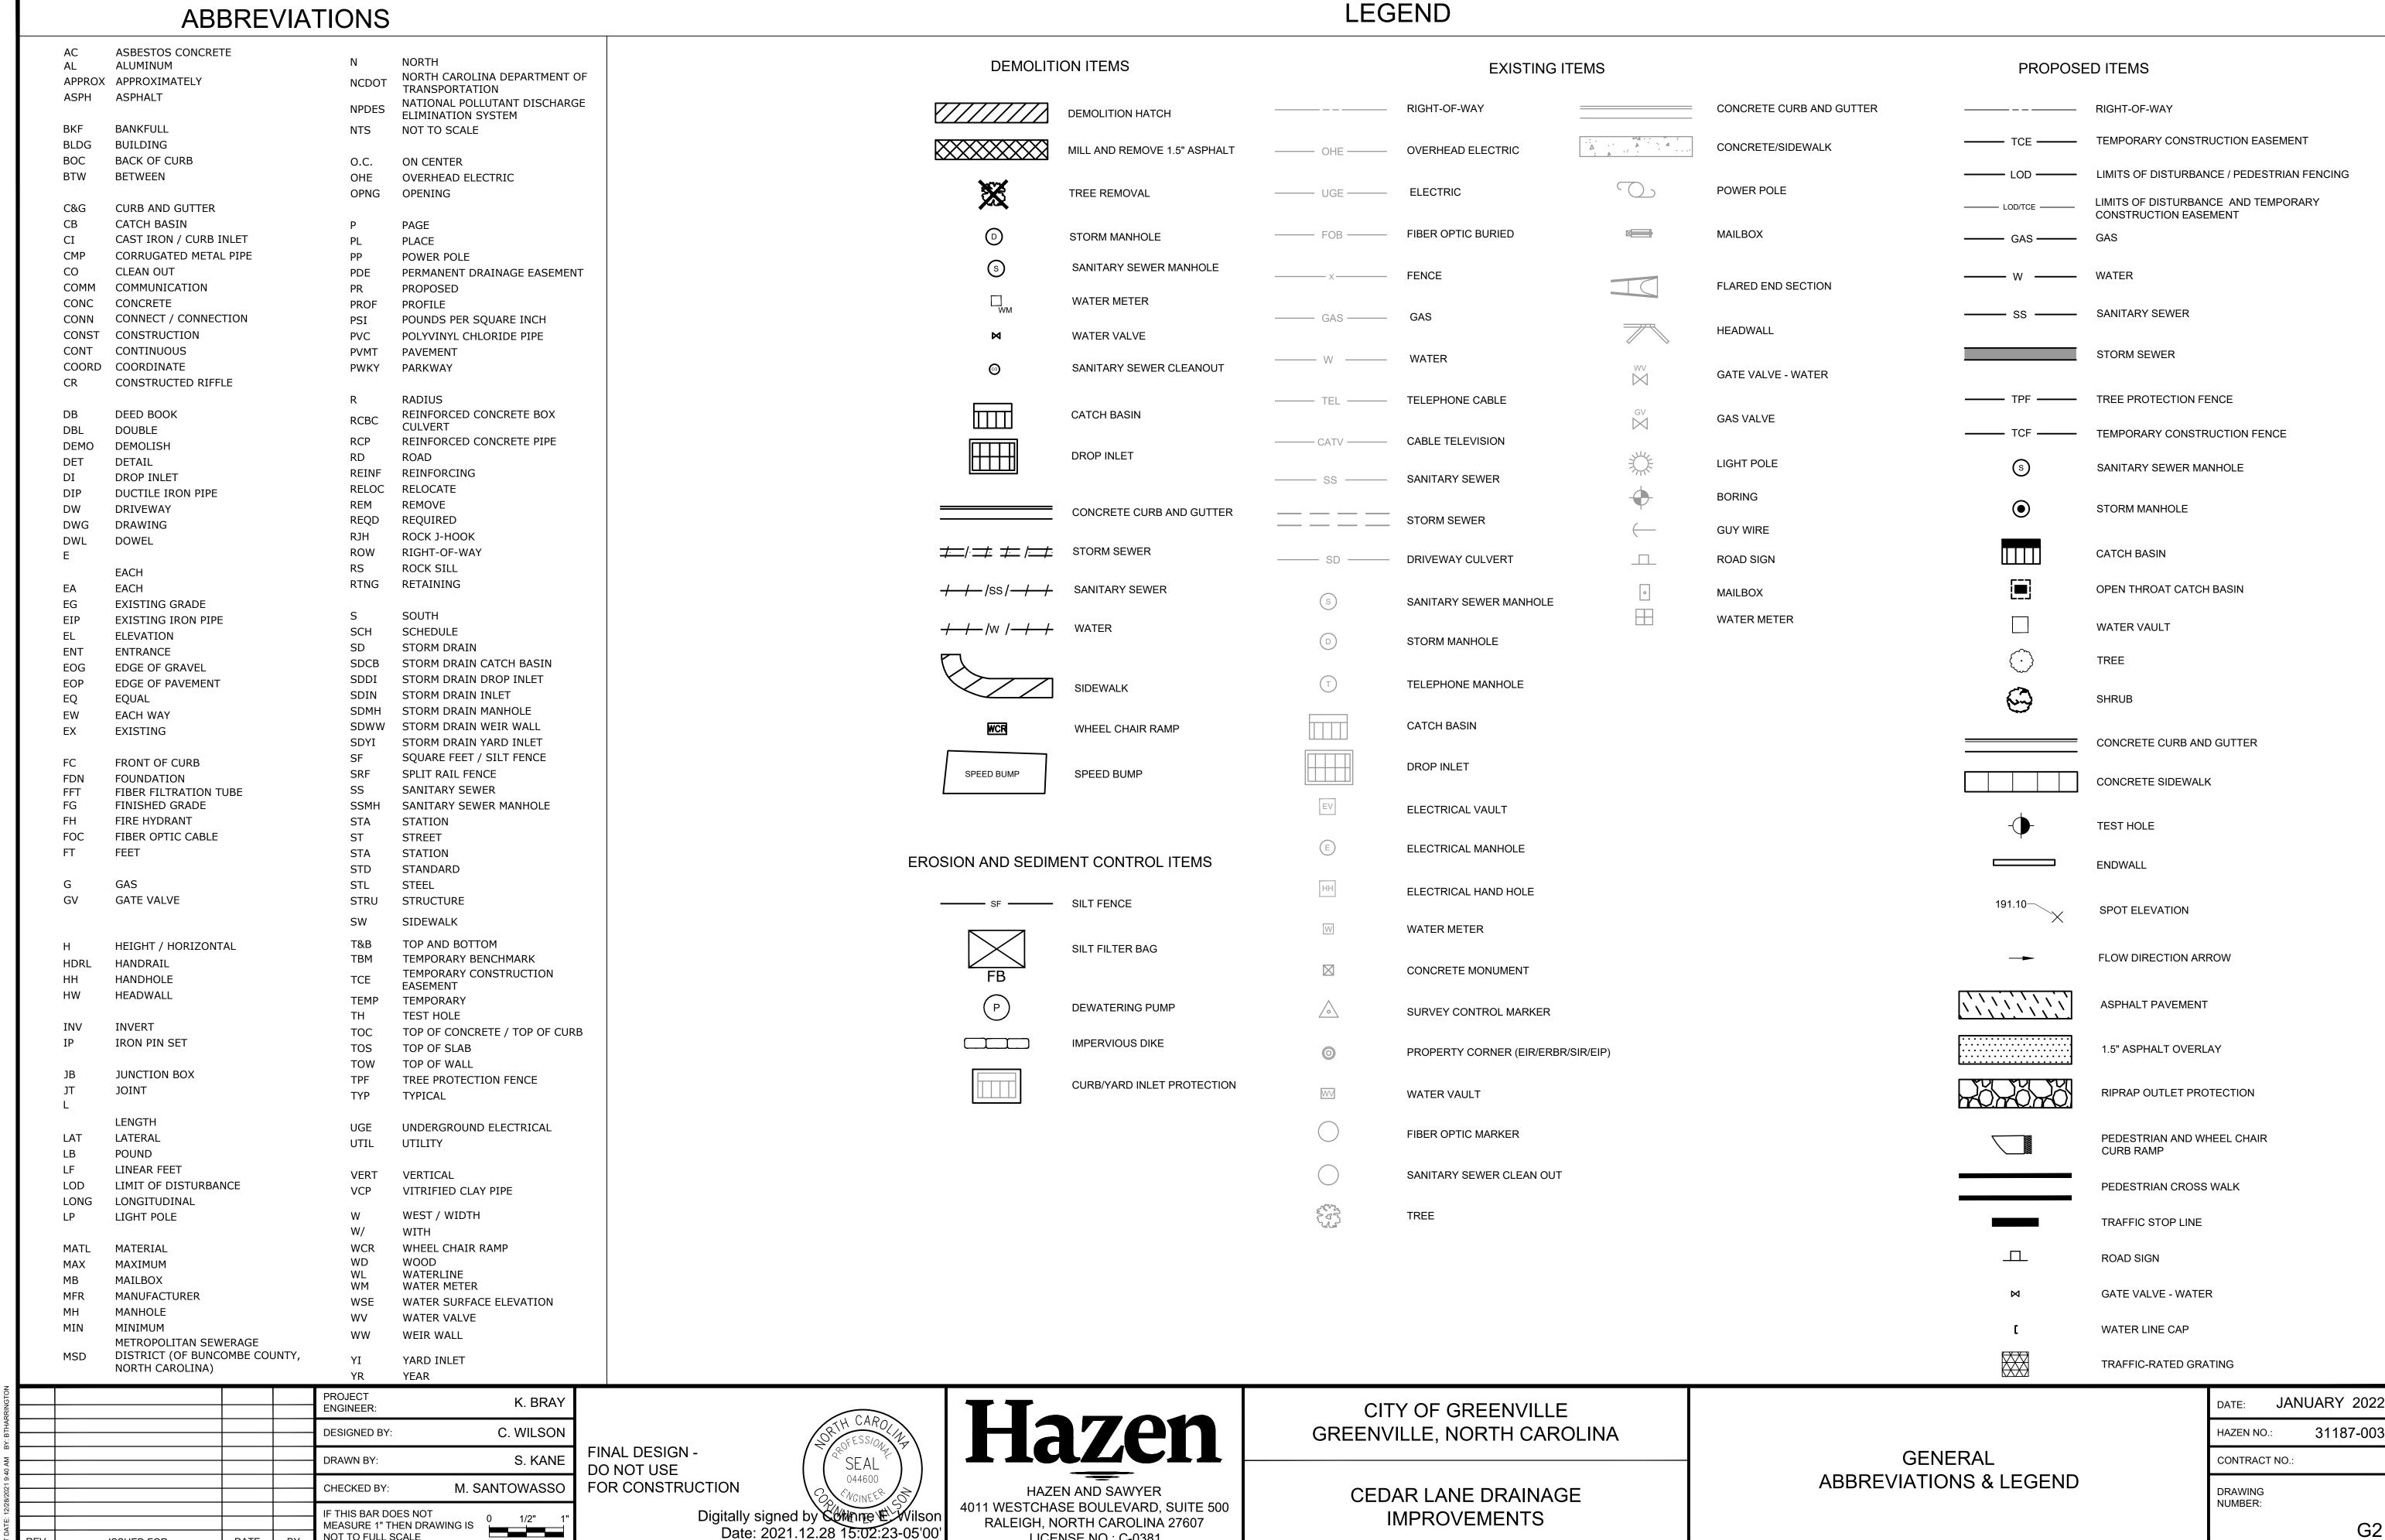

LICENSE NO.: C-0381

ISSUED FOR

NOT TO FULL SCALE

- SITE INFORMATION HAS BEEN PROVIDED BY SITE SURVEY PREPARED BY COOPER AND ASSOCIATES SURVEYORS,
- HORIZONTAL CONTROL IS REFERENCED TO THE NORTH CAROLINA STATE PLANE COORDINATE SYSTEM, BASED ON THE NORTH AMERICAN DATUM OF 1983 (NAD 83). VERTICAL CONTROL IS REFERENCED TO THE NORTH AMERICAN VERTICAL DATUM OF 1988 (NAVD 88).
- FLOOD PLAIN ELEVATIONS FROM FEDERAL EMERGENCY MANAGEMENT AGENCY (FEMA) FLOOD INSURANCE RATE MAP (FIRM) PANEL 4697, MAP NUMBER 3720469700K, DATED JULY 7, 2014 100-YEAR FLOOD ELEVATION = 35.4
- CONTRACTOR SHALL OBTAIN ALL THE NECESSARY PERMITS FROM THE APPROPRIATE AUTHORITIES, DEPARTMENTS, AND/OR AGENCIES HAVING JURISDICTION PRIOR TO COMMENCING WORK
- CONTRACTOR SHALL TAKE CARE TO AVOID DAMAGE TO EXISTING PAVEMENT, TREES, VEGETATION, STRUCTURES, AND UTILITIES THAT ARE NOT INDICATED TO BE DEMOLISHED OR REMOVED. ANY DAMAGE TO EXISTING PAVEMENT, TREES, VEGETATION, STRUCTURES, AND UTILITIES NOT INDICATED TO BE DEMOLISHED OR REMOVED SHALL BE REPAIRED AT THE CONTRACTOR'S EXPENSE.
- WHERE PROPOSED WORK IS IN THE VICINITY OF UTILITY POLES, SUCH THAT SUPPORT OF THE POLE(S) WILL BE REQUIRED, THE CONTRACTOR SHALL BE RESPONSIBLE FOR NOTIFYING THE UTILITY, PUBLIC OR PRIVATE, OF THE WORK. IT WILL BE THE RESPONSIBILITY OF THE CONTRACTOR TO COORDINATE WITH THE UTILITY FOR SUPPORT
- WHERE OVERHEAD POWER LINES ARE PRESENT, CONTRACTOR MUST CONTACT THE UTILITY PRIOR TO CONSTRUCTION ACTIVITIES TO DETERMINE THE MINIMUM REQUIRED EQUIPMENT CLEARANCE (MEC) DISTANCE BASED UPON LINE STRENGTH.
- THE CONTRACTOR SHALL DESIGN, FURNISH, AND INSTALL ANY TRENCH OR EXCAVATION STABILIZATION NECESSARY TO MAINTAIN EXCAVATION FOR CONSTRUCTION OF IMPROVEMENTS. CONTRACTOR SHALL COMPLY WITH ALL APPLICABLE SAFETY REGULATIONS AND SHALL SUBMIT A DESIGN PREPARED BY A REGISTERED PROFESSIONAL ENGINEER IN THE JURISDICTION OF THE PROJECT TO THE OWNER/ENGINEER FOR REVIEW INCLUDING BUT NOT LIMITED TO SHEET PILING, SHORING, AND/OR BRACING. THE CONTRACTOR SHALL BE RESPONSIBLE FOR INSTALLATION AND REMOVAL OF ANY TRENCH STABILIZATION. THE CONTRACTOR SHALL ALSO BE RESPONSIBLE FOR ANY DAMAGE TO ADJACENT UTILITIES OR STRUCTURES RESULTING FROM THE INSTALLATION, REMOVAL OR ABSENCE OF TRENCH STABILIZATION.
- ALL MATERIALS, CONSTRUCTION METHODS, AND WORKMANSHIP SHALL CONFORM WITH THE LATEST VERSION OF APPLICABLE LOCAL, STATE, AND FEDERAL STANDARDS AND REQUIREMENTS.
- CONTRACTOR SHALL MAKE EVERY EFFORT TO SAVE AND MAINTAIN ALL PROPERTY IRONS, MONUMENTS, OTHER PERMANENT POINTS AND LINES OF REFERENCE AND CONSTRUCTION STAKES. A REGISTERED LAND SURVEYOR AT THE CONTRACTOR'S EXPENSE SHALL REPLACE PROPERTY IRONS, MONUMENTS, AND OTHER PERMANENT POINTS OF REFERENCE DISTURBED OR DESTROYED BY THE CONTRACTOR.
- ACCESS TO SITES SHALL BE BY PUBLIC RIGHT-OF-WAYS AND UTILITY EASEMENTS. OTHER ACCESS LOCATIONS REQUIRED SHALL BE SECURED BY THE CONTRACTOR AT NO ADDITIONAL EXPENSE TO THE OWNER. SUPPLEMENTAL EROSION CONTROL MEASURES SHALL BE REQUIRED TO INCLUDE CONSTRUCTION ENTRANCES, SILT FENCING, RESTORATION, ETC. ADDITIONAL MEASURES SHALL BE INCLUDED AS PART OF A SUPPLEMENTAL EROSION CONTROL PLAN PREPARED BY THE CONTRACTOR.
- . THE CONTRACTOR SHALL BE REQUIRED TO PROVIDE THE CONSTRUCTION LAYDOWN AREA AT HIS EXPENSE IF NOT SHOWN ON DRAWINGS.
- . ANY ONSITE STOCKPILING IS TO BE COORDINATED AND APPROVED BY THE OWNER/ENGINEER. THE STOCKPILE SHALL BE PROVIDED WITH GROUND COVER WITHIN 15 WORKING DAYS OF STOCKPILE COMPLETION.
- CONTRACTOR SHALL PERFORM ALL WORK IN ACCORDANCE WITH CURRENT OSHA REGULATIONS.
- . THE CONTRACTOR IS EXPECTED AND REQUIRED TO COOPERATE WITH THE PROPERTY OWNERS AFFECTED BY THE WORK. PRIVATE AGREEMENTS WITH PROPERTY OWNERS MUST BE IN WRITING ON A FORM APPROVED BY THE OWNER AND A COPY SHALL BE PROVIDED TO THE ENGINEER PRIOR TO PROCEEDING WITH CONSTRUCTION ACTIVITIES AFFECTED BY SAID AGREEMENT. THE AGREEMENT MUST SPECIFY THAT THE OWNER AND THE ENGINEER SHALL BE INDEMNIFIED AND HELD HARMLESS AGAINST ALL CLAIMS ARISING FROM THE AGREEMENT BEFORE FINAL ACCEPTANCE, A RELEASE FROM EACH PROPERTY OWNER THAT THE CONTRACTOR MADE AN AGREEMENT WITH SHALL BE REQUIRED. THE PROPERTY OWNER'S RELEASE IS A CONDITION OF FINAL ACCEPTANCE.
- . CONTRACTOR SHALL MAINTAIN A NEAT AND CLEAN JOB-SITE TO INCLUDE LAYDOWN/STORAGE AREAS AS FOLLOWS
- PERFORM DUST CONTROL BY WATERING DAILY OR AS DIRECTED BY THE OWNER/ENGINEER
- SWEEP STREETS A MINIMUM OF ONCE WEEKLY (FRIDAY) OR AS DIRECTED BY THE ENGINEER/OWNER.
- BLADE, LEVEL AND RE-COMPACT ALL EXPOSED TRENCHES WEEKLY (OR AS DIRECTED BY THE ENGINEER/OWNER) TO PRODUCE A SMOOTH "RIDE"
- PERFORM DAILY CLEAN-UP OF ALL DIRT, DEBRIS, TRASH, AND SCRAP MATERIALS.
- REMOVE EXCESS EQUIPMENT, MATERIALS, TOOLS, ETC. NOT NEEDED.
- EXCESS SUITABLE SOIL EXCAVATED DURING CONSTRUCTION SHALL BE STOCKPILED FOR USE ON THE PROJECT OR DISPOSED OF OFF-SITE AS DIRECTED BY THE ENGINEER/OWNER. THE CONTRACTOR SHALL NOT BE ALLOWED TO STOCKPILE MATERIALS OR EXCESS MATERIALS IN THE STREET RIGHT-OF-WAYS AT ANY TIME. THE CONTRACTOR SHALL PROVIDE A SUFFICIENT AND SUITABLE STOCKPILE AREA AND LOCATION AT THE CONTRACTOR'S EXPENSE UNLESS SUCH AN AREA IS DESIGNATED ON THE DRAWINGS.
- THE CONTRACTOR SHALL PROVIDE MEANS TO DEWATER THE CONSTRUCTION AREA DURING CONSTRUCTION. ALL CONSTRUCTION WORK SHALL BE PERFORMED IN THE DRY. DISCHARGES FROM DEWATERING ACTIVITIES WILL BE DISCHARGED THROUGH A SEDIMENT FILTERING DEVICE AND SHALL BE DISCHARGED IN A NON-EROSIVE MANNER IN COMPLIANCE WITH APPLICABLE LOCAL, STATE, AND FEDERAL STANDARDS AND REGULATIONS.
- CONTRACTOR SHALL PROVIDE MEASURES DURING CONSTRUCTION TO SECURE THE SITE AND EXCAVATION FROM THE GENERAL PUBLIC AND COMPLY WITH ALL OSHA REGULATIONS. JOB SITE SAFETY IS THE EXCLUSIVE AND SOLE RESPONSIBILITY OF THE CONTRACTOR. OPEN EXCAVATION SHALL BE FILLED AT THE END OF EACH DAY'S WORK AND SHALL NOT BE LEFT UNATTENDED OR OPEN OVERNIGHT. FOR AREAS LEFT OPEN OVERNIGHT, SECURITY FENCING SHALL BE PROVIDED.
- CONTRACTOR SHALL REPAIR OR REPLACE DRIVEWAYS DISTURBED BY CONSTRUCTION TO EXISTING OR BETTER CONDITIONS. NO SEPARATE PAYMENT UNLESS OTHERWISE INDICATED.
- . THE CONTRACTOR SHALL OBTAIN OWNER APPROVAL TO REMOVE ANY TREES NOT INDICATED FOR REMOVAL ON THE DRAWINGS.
- . CONTRACTOR SHALL PROVIDE TEMPORARY FENCING WERE FENCES ARE REMOVED FOR CONSTRUCTION. CONTRACTOR SHALL COORDINATE REMOVAL OF EXISTING FENCE AND INSTALLATION OF TEMPORARY FENCE WITH PROPERTY OWNER PRIOR TO CONSTRUCTION. REMOVAL OF TEMPORARY FENCE AND INSTALLATION OF PERMANENT FENCE MUST ALSO BE COORDINATED WITH PROPERTY OWNER. ALL REMOVAL, TEMPORARY, AND REPLACEMENT FENCING SHALL BE CONSIDERED INCIDENTAL TO THE INSTALLATION AND NO SEPARATE PAYMENT SHALL BE MADE UNLESS OTHERWISE INDICATED. CONTRACTOR SHALL REINSTALL ALL SHEDS, FENCES, ETC. TO AS GOOD OR BETTER THAN EXISTING CONDITIONS UNLESS OTHERWISE INDICATED WITH NO SEPARATE PAYMENT UNLESS OTHERWISE INDICATED.
- CONTRACTOR SHALL REPLACE ALL DISTURBED MAILBOXES, SIGNS, ETC. DISTURBED DURING CONSTRUCTION WITHIN 24 HOURS OF DISTURBANCE. PERMANENT ROAD SIGNAGE DISTURBED SHALL BE REPLACED IMMEDIATELY AND IF NECESSARY, ROADWAY SIGNS SHALL BE TEMPORARILY INSTALLED IN A LOCATION CONSISTENT WITH MUTCD TO PROVIDE CONTINUOUS TRAFFIC AWARENESS OF ROADWAY CONDITIONS. (NO SEPARATE PAYMENT UNLESS OTHERWISE INDICATED).

PROJECT

ENGINEER:

- 24. CONTRACTOR SHALL PROVIDE SECURITY FENCING, SECURITY GUARD, AND ANY AND ALL OTHER MEASURES CONTRACTOR DEEMS NECESSARY TO PROTECT EQUIPMENT AND MATERIALS STORED ON THE PROJECT. (NO SEPARATE PAYMENT UNLESS OTHERWISE INDICATED).
- 25. WHERE CONTRACTOR CEASES WORK OPERATION FOR A 72 HOUR PERIOD OR LONGER, SUCH AS HOLIDAYS, ETC., THE FOLLOWING SHALL BE ACCOMPLISHED PRIOR TO THE WORK STOPPAGE.
- CONTRACTOR WILL STORE ALL EQUIPMENT IN THE CONTRACTOR LAYDOWN AREA OR OFFSITE.
- THE CONTRACTOR SHALL SWEEP ALL STREETS, PERFORM GENERAL CLEANUP AND SHALL PERFORM MAINTENANCE ON ALL EXPOSED PATCHES.
- 26. CONTRACTOR SHALL SCHEDULE WORK AND MATERIAL DELIVERIES SO THAT STORED MATERIAL QUANTITIES ON THE JOB SITE SHALL BE MINIMIZED.
- 27. CONTRACTOR SHALL STORE ALL MATERIALS IN THE CONTRACTOR LAYDOWN AREA NO MORE THAN 72 HOURS PRIOR TO INCORPORATING INTO THE WORK TO REDUCE OBSTRUCTIONS TO TRAFFIC AND INCONVENIENCE TO RESIDENTS. WHERE UTILITIES ARE BEING CONSTRUCTED IN EASEMENTS OUT OF TRAFFIC AREAS CONTRACTOR MAY STORE MATERIAL AHEAD OF CONSTRUCTION FOR A DISTANCE NOT GREATER THAN 1800 FEET UNLESS APPROVED OTHERWISE BY THE ENGINEER/OWNER.
- AT THE PROPERTY OWNER'S REQUEST, THE CONTRACTOR SHALL DIG UP EXISTING SHRUBS AND BUSHES WITHIN UTILITY EASEMENT TO BE DISTURBED BY CONSTRUCTION AND SET OUTSIDE THE UTILITY EASEMENT AREA IN A LOCATION DETERMINED BY THE PROPERTY OWNER (NO SEPARATE PAYMENT UNLESS OTHERWISE INDICATED). PROPERTY OWNER WILL BE RESPONSIBLE FOR REPLANTING SHRUBS AND BUSHES SO REMOVED AND SHALL BE RESPONSIBLE FOR RE-ESTABLISHING GROWTH. IF NO REQUEST IS MADE BY THE PROPERTY OWNER, DISTURBED SHRUBS AND BUSHES SHALL BE REMOVED AND DISPOSED OF OFFSITE UNLESS OTHERWISE INDICATED.
- 29. CLEARING AND GRUBBING SHALL BE RESTRICTED TO PERMANENT EASEMENTS ONLY. CONTRACTOR SHALL LIMIT TREE/BUSH CLEARING IN THE TEMPORARY EASEMENTS, BETWEEN HOUSES AND ALONG PROPERTY LINES TO ONLY ABSOLUTELY NECESSARY FOR CONSTRUCTION OR AS NOTED ON PLANS.
- 30. CONTRACTOR SHALL NOT DISTURB ANY AREAS OUTSIDE OF THE DESIGNATED EASEMENT AREAS AND/OR LIMITS OF DISTURBANCE.
- 31. THE CONTRACTOR SHALL MAINTAIN EROSION CONTROL DEVICES IN ACCORDANCE WIH THE APPROPRIATE LOCAL AND STATE EROSION AND SEDIMENT CONTROL ORDINANCES. THE CONTRACTOR SHALL PREVENT STANDING WATER DUE TO CONSTRUCTION.
- 32. THE CONTRACTOR SHALL SAWCUT EXISTING ASPHALT AND/OR CONCRETE SURFACES PRIOR TO REMOVAL UNLESS OTHERWISE DIRECTED BY THE ENGINEER/OWNER. PAVEMENT REMOVAL WIDTH SHALL BE 1 FOOT MINIMUM. REMOVED PAVEMENT SHALL BE REPLACED AS WELL AS ADDITIONAL PAVEMENT REQUIRED TO TIE-IN TO FACE OF PROPOSED CURB OR GUTTER.
- 33. THE CONTRACTOR SHALL BE RESPONSIBLE FOR ALL BORROW MATERIAL REQUIRED TO CONSTRUCT PROJECT AS SHOWN ON THE CONTRACT DOCUMENTS UNLESS OTHERWISE INDICATED.
- 34. ALL EXCAVATED MATERIALS THAT ARE NOT REQUIRED OR ARE UNSUITABLE FOR THE PROJECT SHALL BE CONSIDERED WASTE AND SHALL BE HAULED OFF SITE AND DISPOSED IN A SAFE AND LEGAL MANNER AT THE CONTRACTOR'S EXPENSE.

#### NOTES FOR PRIVATE PROPERTY OWNER RELATIONS:

- 1. IF THE PROPOSED WORK WILL BE CONSTRUCTED WITHIN A DEVELOPED RESIDENTIAL OR COMMERCIAL AREA, THE CONTRACTOR IS REQUIRED TO DEVELOP GOOD RELATIONS WITH THE RESIDENTS AND BUSINESSES WHICH INCLUDE THE FOLLOWING MANDATORY MINIMUM REQUIREMENTS:
  - NO SPEEDING WITH EQUIPMENT AND/OR VEHICLES (25 MPH MAX.)
  - DO NOT BLOCK DRIVEWAYS AT ANY TIME EXCEPT AS INDICATED
  - DO NOT LITTER AT ANY TIME
  - DO NOT USE PRIVATE PROPERTY OWNER WATER WITHOUT PROPERTY OWNER PERMISSION (SIGNED) AGREEMENT REQUIRED)
  - ADHERE TO ALL PLUMBING CODE REQUIREMENTS FOR BACK FLOW PREVENTION
- RESPOND TO RESIDENT'S COMPLAINTS WITHIN 24 HOURS DO NOT HARASS OR USE ABUSIVE LANGUAGE OR PROFANITY
- WEAR PROPER PROTECTIVE CLOTHING (HARD HATS, PROPER SHOES, SHIRTS, ETC.) AS REQUIRED BY
- CONTRACTOR SAFETY POLICY AND OSHA. MAINTAIN PROPER SAFETY MEASURES, PARTICULARLY ALONG OPEN TRENCHES, PLACING CONES ON RAISED MANHOLES AND BACK FILLING OPEN TRENCHES IF CONSTRUCTION IS STOPPED AND THE OPEN TRENCH IS NOT MANNED
- PERSONNEL MUST WEAR SAFETY VEST AT ALL TIMES WHILE WORKING IN THE PUBLIC RIGHT-OF-WAY.
- ALL TRAFFIC CONTROL FLAG PERSONS AND AT LEAST ONE PERSON ON EACH WORK CREW MUST BE FLUENT IN THE ENGLISH LANGUAGE
- 2. IF THE CONTRACTOR AND/OR SUBCONTRACTORS CANNOT ADEQUATELY PERFORM AND/OR COMPLY WITH THESE REQUIREMENTS, THE INDIVIDUAL, SUBCONTRACTOR, OR EMPLOYEES MAY BE DIRECTED TO LEAVE THE PROJECT PERMANENTLY. INCONSIDERATE, NON-COOPERATIVE ATTITUDES AND ACTIONS WILL NOT BE

#### ORDER OF PRECEDENCE GENERAL NOTES/TECHNICAL SPECIFICATIONS/PHOTOS:

- 1. THE NOTES CONTAINED HEREIN ARE INTENDED TO SUPPLEMENT TECHNICAL SPECIFICATIONS. IN NO CASE SHALL THESE NOTES VOID ANY PART, SECTION OR REQUIREMENT OUTLINED IN THE TECHNICAL SPECIFICATIONS CONTAINED IN THE CONTRACT DOCUMENTS. IF CONFLICTS OCCUR BETWEEN THE TECHNICAL SPECIFICATIONS AND THE NOTES CONTAINED HEREIN, THE TECHNICAL SPECIFICATIONS SHALL SUPERSEDE.
- PHOTOGRAPHS CONTAINED IN DRAWINGS, IF ANY, ARE FOR INFORMATIONAL PURPOSES ONLY AND THE CONTRACTOR SHALL NOT RELY ON THE PHOTOGRAPHS AS BEING REPRESENTATIVE OF ACTUAL SITE CONDITIONS. CONTRACTOR IS RESPONSIBLE FOR PERFORMING SITE INVESTIGATIONS TO ASCERTAIN EXISTING SITE CONDITIONS.

#### TRAFFIC CONTROL

- 1. CONTRACTOR SHALL COMPLY WITH THE TRAFFIC CONTROL PLAN AS SHOWN IN THE DRAWINGS. IF NO TRAFFIC CONTROL PLAN IS INCLUDED IN THE DRAWINGS, OR IF THE CONTRACTOR WISHES TO PROPOSE AN ALTERNATIVE TRAFFIC CONTROL PLAN, CONTRACTOR SHALL PROVIDE A TRAFFIC CONTROL PLAN TO THE ENGINEER/OWNER FOR APPROVAL. TRAFFIC CONTROL PLAN SHALL COMPLY WITH ALL LOCAL, STATE, FEDERAL, AND MUTCD REQUIREMENTS.
- 2. CONTRACTOR SHALL ENSURE ACCESS TO ALL PROPERTIES BY PROPERTY OWNERS AT ALL TIMES. TEMPORARY DRIVEWAY CLOSURES SHALL ONLY BE PERMITTED ONLY WITH APPROVAL OF THE OWNER AND IN COORDINATION WITH THE PROPERTY OWNER. FOR DRIVEWAY CLOSURES, CONTRACTOR SHALL PROVIDE ALTERNATE PARKING AND PEDESTRIAN ACCESS TO HOMES TO THE PROPERTY OWNER'S SATISFACTION.
- CONTRACTOR SHALL NOTIFY THE OWNER ONE WEEK IN ADVANCE OF ANY ROAD CLOSING AND COORDINATE ALL ROAD CLOSINGS WITH AFFECTED PROPERTY OWNERS 48 HOURS PRIOR TO CLOSING.
- 4. MINIMUM ONE-WAY TRAFFIC SHALL BE MAINTAINED AT ALL TIMES UNLESS ROAD CLOSURE IS APPROVED BY THE OWNER IN WRITING 5 DAYS IN ADVANCE OF ROAD CLOSURE. AN APPROVED DETOUR PLAN PREPARED BY THE CONTRACTOR SHALL BE REQUIRED AND THE MEASURES INSTALLED PRIOR TO CLOSURE.
- ARE IN PLACE. 6. ALL TRAFFIC CONTROL MEASURES, DEVICES, INSTALLATION, METHODS, SEQUENCING AND PLANS SHALL BE IN

STRICT ACCORDANCE WITH MUTCD AND ALL APPLICABLE LOCAL, STATE, AND FEDERAL STANDARDS.

SEAL

5. THE CONTRACTOR SHALL NOT IMPEDE TRAFFIC AT ANY TIME UNTIL THE APPROVED TRAFFIC CONTROL DEVICES

HAZEN AND SAWYER 4011 WESTCHASE BOULEVARD, SUITE 500 RALEIGH, NORTH CAROLINA 27607 LICENSE NO.: C-0381

#### UTILITIES:

- 1. CONTRACTOR SHALL REFERENCE AND MEET THE REQUIREMENTS OF THE GUC DESIGN AND SPECIFICATIONS MANUAL, REFERRED TO HEREAFTER AS THE GUC MANUAL.
- INTERRUPTION OF UTILITY SERVICE TO RESIDENCES OR BUSINESSES REQUIRES APPROVAL OF THE UTILITY OWNER. IF APPROVED, UTILITY OWNER AND AFFECTED RESIDENTS/BUSINESSES SHALL BE NOTIFIED A MINIMUM OF 48 HOURS IN ADVANCE OF SERVICE INTERRUPTION.
- 3. WHEN CONSTRUCTION REQUIRES RELOCATION OF SANITARY SEWER SERVICE LATERALS, CONTRACTOR SHALL PROVIDE MEANS OF COLLECTING AND DISPOSING OF RESIDENTIAL/BUSINESS SANITARY SEWAGE.
- UTILITIES ARE SHOWN BASED ON BEST INFORMATION AVAILABLE. THE CONTRACTOR SHALL FIELD-VERIFY LOCATIONS OF UTILITIES WHERE SHOWN PRIOR TO LAND DISTURBANCE.
  - THE CONTRACTOR SHALL CONTACT NORTH CAROLINA ONE-CALL @ 811 TO HAVE UTILITIES LOCATED PRIOR TO BEGINNING CONSTRUCTION.
- 5. PRIOR TO CONSTRUCTION, THE CONTRACTOR SHALL NOTIFY AND MEET WITH ALL UTILITY OWNERS, THE OWNER'S UTILITY COORDINATOR AND OWNER'S INSPECTOR WHOSE FACILITIES WILL BE AFFECTED TO DETERMINE UTILITY LOCATIONS. THE CONTRACTOR SHALL PROTECT ALL UTILITIES FROM DAMAGE CAUSED BY CONTRACTOR OPERATIONS OR THOSE OF THE CONTRACTOR'S AGENTS. THE CONTRACTOR SHALL INDEMNIFY AND HOLD HARMLESS THE OWNER AND ENGINEER FOR ANY THIRD-PARTY INCONVENIENCE CREATED BY THE CONTRACTOR'S OPERATIONS OR THAT OF HIS AGENTS. ANY DAMAGES TO EXISTING UTILITIES SHALL BE THE CONTRACTOR'S FINANCIAL RESPONSIBILITY.
- 6. ADJUSTMENTS/RELOCATIONS WILL BE PERFORMED BY THE VARIOUS UTILITY OWNERS. THE CONTRACTOR SHALL COORDINATE UTILITY ADJUSTMENT/RELOCATION WORK WITH UTILITY OWNERS SO AS NOT TO DELAY THE PROJECT SCHEDULE. THE CITY WILL NOT BE HELD RESPONSIBLE FOR ANY DELAYS OR DISRUPTIONS DUE TO THE WORK SCHEDULE OF UTILITY OWNERS.
  - CONTRACTOR SHALL CONTACT GUC AT LEAST TWO (2) WEEKS PRIOR TO ANY ANTICIPATED COORDINATION NEED FOR GAS, ELEC, AND SS UTILITIES. CONTRACTOR SHALL COORDINATE WITH:

GAS: DILLON WADE: (252) 551-1594 ELEC: BRIAN MURPHY, (252) 329-2173, JEFF OAKLEY, (252) 551-1584 SS: SCOTT FARMER, (252) 551-1529

- FOR ALL OTHER UTILITIES, CONTACT THE UTILITY OWNER FOR COORDINATION.
- 7. THE CONTRACTOR SHALL ADJUST ALL WATER VALVES, WATER METER BOXES AND WATER VAULTS TO FINISHED GRADE. THE CONTRACTOR SHALL FOLLOW STANDARDS OF THE GUC MANUAL.
- 8. ALL UTILITY CONSTRUCTION SHALL COMPLY WITH APPLICABLE LOCAL AND STATE CONSTRUCTION AND TESTING STANDARDS.
- 9. PRIOR TO COMMENCEMENT OF ANY WORK WITHIN EASEMENTS OR RIGHT-OF-WAYS, THE CONTRACTOR IS REQUIRED TO NOTIFY CONCERNED UTILITY COMPANIES IN ACCORDANCE WITH LOCAL AND STATE LAWS AND REGULATIONS. CONTRACTOR SHALL VERIFY LOCATION OF EXISTING UTILITIES, INCLUDING ANY NOT SHOWN, PRIOR TO BEGINNING CONSTRUCTION.
- 10. THE CONTRACTOR SHALL DIG UP EACH UTILITY WHICH MAY CONFLICT WITH CONSTRUCTION 14 DAYS IN ADVANCE TO VERIFY LOCATIONS (HORIZONTALLY AND VERTICALLY) TO ALLOW THE ENGINEER AN OPPORTUNITY TO ADJUST THE DESIGN TO AVOID CONFLICTS (NO SEPARATE PAYMENT UNLESS OTHERWISE
- 11. STORM DRAINAGE REPAIRS BY CONTRACTOR DUE TO CONSTRUCTION DAMAGE AND JOINTS EXPOSED DURING CONSTRUCTION SHALL BE INSPECTED BY THE OWNER PRIOR TO BACKFILLING.
- 12. THE CONTRACTOR IS RESPONSIBLE FOR SUPPORT OF EXISTING UTILITIES AS REQUIRED FOR CONSTRUCTION OF IMPROVEMENTS SHOWN. CONTRACTOR SHALL PROVIDE OWNER A UTILITY SUPPORT PLAN DESIGNED AND SEALED BY A NORTH CAROLINA PROFESSIONAL ENGINEER.
- 13. THE CONTRACTOR SHALL PROVIDE SANITARY SEWER BYPASS PUMPING TO A DOWNSTREAM MANHOLE OR OTHER MEANS TO COLLECT AND DISPOSE OF ACTIVE SANITARY SEWER FLOWS AS REQUIRED FOR CONSTRUCTION.

#### STORM DRAINAGE STRUCTURE, PIPE & GRADING NOTES:

- 1. PIPE INVERT ELEVATIONS HAVE PRECEDENCE OVER SLOPES. HOWEVER, SLOPES SHALL NOT BE DECREASED FROM THOSE SHOWN ON PLAN WITHOUT PRIOR APPROVAL FROM THE ENGINEER.
- 2. ALL STORM DRAINAGE PIPE TO BE CLASS III REINFORCED CONCRETE UNLESS OTHERWISE NOTED. PIPE LENGTHS INDICATED ON PLAN ARE APPROXIMATE.
- THE CONTRACTOR SHALL PROVIDE BYPASS PUMPING TO ROUTE ACTIVE DRAINAGE SYSTEM FLOWS AROUND PROPOSED CONSTRUCTION AREA. FLOWS SHALL BE DISCHARGED IN A NON-EROSIVE MANNER. THE CONTRACTOR IS RESPONSIBLE FOR ENSURING THAT BYPASS PUMPING IS ADEQUATE TO PROTECT THE WORK AREA FROM DAMAGE.
- 4. THE CONTRACTOR SHALL IMMEDIATELY REPORT TO THE OWNER/ENGINEER ANY DISCREPANCIES FOUND BETWEEN ACTUAL CONDITIONS AND CONSTRUCTION DOCUMENTS AND SHALL WAIT FOR FURTHER COORDINATION FROM THE OWNER/ENGINEER BEFORE PROCEEDING WITH CONSTRUCTION.
- MANHOLE RIM ELEVATIONS SHOWN ON THE PLANS ARE APPROXIMATE. NEW MANHOLE RING AND COVERS SHALL BE INSTALLED FLUSH WITH THE SURROUNDING GRADE SO AS TO AVOID DAMAGE TO MOTOR VEHICLES. THEY SHALL BE ADJUSTED TO MATCH THE SURROUNDING PROPOSED GRADE PRIOR TO PLACING THE NEW SURFACE COURSE.
- GRADES, ELEVATIONS AND LOCATIONS SHOWN ARE APPROXIMATE, AS DIRECTED BY THE ENGINEER/OWNER. THEY MAY BE ADJUSTED TO ACCOMMODATE UNFORESEEN CONDITIONS WITH OWNER/ENGINEER APPROVAL CONTRACTOR SHALL PROVIDE TRENCH STABILIZATION PLAN DESIGNED AND SEALED BY A NORTH CAROLINA PROFESSIONAL ENGINEER.
- THE CONTRACTOR SHALL BACKFILL OPEN EXCAVATIONS AT THE END OF EACH WORKING DAY. AT DRAINAGE STRUCTURE LOCATIONS, THE EXCAVATION SHALL BE COVERED WITH METAL PLATES UNLESS OTHERWISE APPROVED BY THE OWNER/ENGINEER. FOR AREAS LEFT OPEN OVERNIGHT, SECURITY FENCING SHALL BE
- 8. ALL PROPOSED GRADES ARE FINISH GRADES. IN RIPRAP AREAS, CONTOURS INDICATE TOP GRADE OF RIPRAP

#### NOTIFICATION OF LAND RESOURCES SEDIMENT AND EROSION CONTROL **SELF-INSPECTION PROGRAM:**

1. THE SEDIMENTATION POLLUTION CONTROL ACT WAS AMENDED IN 2006 TO REQUIRE THAT PERSONS RESPONSIBLE FOR LAND DISTURBING ACTIVITIES INSPECT A PROJECT AFTER EACH PHASE OF THE PROJECT TO MAKE SURE THAT THE APPROVED EROSION AND SEDIMENTATION CONTROL PLAN IS BEING FOLLOWED. RULES DETAILING THE DOCUMENTATION OF THESE INSPECTIONS TOOK EFFECT OCTOBER 1, 2010. THE SELF-INSPECTION PROGRAM IS SEPARATE FROM THE WEEKLY SELF MONITORING PROGRAM OF THE NPDES STORMWATER PERMIT FOR CONSTRUCTION ACTIVITIES. THE FOCUS OF THE SELF-INSPECTION REPORT IS THE INSTALLATION AND MAINTENANCE OF EROSION AND SEDIMENTATION CONTROL MEASURES ACCORDING TO THE APPROVED PLAN. THE INSPECTIONS MUST BE CONDUCTED AFTER EACH PHASE OF THE PROJECT, AND CONTINUED UNTIL PERMANENT GROUND COVER IS ESTABLISHED IN ACCORDANCE WITH THE NCGS 113A 54.1 AND 15A NCAC 4B.0131. THE SELF-INSPECTION REPORT FORM IS AVAILABLE AT https://deq.nc.gov/about/divisions/energy-mineral-land-resources/erosion-sediment-control/forms. IF YOU HAVE ANY

QUESTIONS OR CANNOT ACCESS THE FORM, PLEASE CONTACT THIS OFFICE AT (910) 433-3300.

#### **SEEDING NOTES:**

SEEDING SHALL BE APPLIED PER CITY OF GREENVILLE EROSION CONTROL GUIDE, DETAIL 310.01 / CD1. ADDITIONALLY, THE FOLLOWING NOTES APPLY:

#### SEED BED PREPARATION

1. CONTRACTOR SHALL PREPARE ALL AREAS TO RECEIVE TEMPORARY OR PERMANENT SEEDING MEASURES

- 2. TOPSOIL SHALL BE PLACED IN AREAS TO BE SEEDED AND ROUGHENED WITH TRACKED EQUIPMENT OR OTHER SUITABLE MEASURES. SLOPES STEEPER THAN 3:1 MAY BE ROUGHENED BY GROOVING, FURROWING, TRACKING, OR STAIRSTEP GRADING. SLOPES FLATTER THAN 3:1 SHOULD BE GROOVED BY DISKING, HARROWING, RAKING, OPERATING PLANTING EQUIPMENT ON THE CONTOUR.
- 3. SOIL AMENDMENTS INCLUDING, BUT NOT LIMITED TO, LIME AND FERTILIZER SHALL BE SPREAD AS NECESSARY, AND AT THE RATES SHOWN IN THE SEEDING SCHEDULE. SEEDING SHALL BE AS PER TYPE AND RATES SHOWN IN THE SEEDING SCHEDULE. SEED SHALL BE BROADCAST AS SOON AS POSSIBLE FOLLOWING ROUGHENING, BEFORE SURFACE HAS BEEN SEALED BY RAINFALL.

- 1. STRAW MULCH MUST COVER A MINIMUM OF 80 PERCENT OF THE SOIL SURFACE AND MUST BE SECURED PER DETAIL 310.01/CD1.
- 2. NETTING WITH PLASTIC MESH AND / OR PLASTIC TWINE SHALL NOT BE USED.

1. NO SEEDING SHOULD BE UNDERTAKEN IN WINDY OR UNFAVORABLE WEATHER, WHEN THE GROUND IS TOO WET TO RAKE EASILY, WHEN IT IS IN A FROZEN CONDITIONS, OR TOO DRY. ANY BARE SPOTS SHOWN IN TWO TO THREE WEEKS SHALL BE RE-CULTIVATED, FERTILIZED AT HALF THE RATE, RAKED, SEEDED, AND MULCHED AGAIN BY MECHANICAL OR HAND BROADCAST METHOD ACCEPTABLE TO THE OWNER.

#### **EROSION & SEDIMENTATION CONTROL NOTES:**

IN ADDITION TO THE NOTES INCLUDED IN DETAIL 310.01/CD1, THE FOLLOWING NOTES APPLY:

- 1. THE CONTRACTOR SHALL PHASE CONSTRUCTION TO MINIMIZE EXPOSED SOIL AREAS. ALL ONSITE ACTIVITIES SHALL BE MANAGED TO ENSURE NO ADVERSE IMPACTS TO WATER QUALITY OCCUR DURING AND AFTER CONSTRUCTION. THE CONTRACTOR SHALL FURNISH AND INSTALL ALL NECESSARY EROSION CONTROL MEASURES WHETHER OR NOT SHOWN ON THE PLANS TO PROTECT ADJACENT CREEKS, ROADWAYS, ETC FROM SILTATION AND EROSION.
- 2. THE NORTH CAROLINA SEDIMENTATION POLLUTION CONTROL ACT REQUIRES PEOPLE RESPONSIBLE FOR LAND DISTURBING ACTIVITIES TO INSPECT EROSION AND SEDIMENTATION CONTROL MEASURES AFTER EACH PHASE OF THE PROJECT UNTIL PERMANENT GROUND COVER IS ESTABLISHED. THE SELF INSPECTION PROGRAM IS SEPARATE FROM THE WEEKLY MONITORING PROGRAM OF THE NPDES STORMWATER PERMIT FOR CONSTRUCTION ACTIVITIES. THE FOCUS OF THE SELF-INSPECTION REPORT IS TO ENSURE THE INSTALLATION OF EROSION AND SEDIMENTATION CONTROL MEASURES ARE CONTINUALLY PERFORMING AS

#### **EROSION & SEDIMENTATION CONTROL CONSTRUCTION SEQUENCING:**

- 1. CONTRACTOR SHALL SIGN AND IMPLEMENT THE REQUIREMENTS OF THE STATE APPROVED EROSION CONTROL PLAN AND THE NORTH CAROLINA NATIONAL POLLUTANT DISCHARGE ELIMINATION SYSTEM (NPDES) GENERAL PERMIT FOR STORMWATER DISCHARGES ASSOCIATED WITH CONSTRUCTION ACTIVITY. THE CONTRACTOR SHALL NOTIFY THE STATE LAND QUALITY SECTION AT (919) 791-4200 TO SCHEDULE A PRE-CONSTRUCTION MEETING. ADDITIONALLY, THE CONTRACTOR SHALL NOTIFY THE STATE LAND QUALITY SECTION, AT (919) 791-4200 AT LEAST 48 HOURS PRIOR TO BEGINNING CONSTRUCTION ACTIVITIES.
- 2. EROSION AND SEDIMENT CONTROL (E&SC) PERMIT AND CERTIFICATE OF COVERAGE (COC) MUST BE OBTAINED BEFORE LAND DISTURBING ACTIVITIES OCCUR. PER NPDES REQUIREMENTS, A RAIN GAUGE, SELF-INSPECTION RECORDS, PERMIT, CERTIFICATE OF COVERAGE, AND S&E PLAN ARE REQUIRED TO BE MAINTAINED ON SITE AND ACCESSIBLE DURING INSPECTION. IT IS RECOMMENDED THAT THESE ITEMS BE PLACED IN A PERMITS BOX AT THE BEGINNING OR ENTRANCE OF THE PROJECT.
- 3. INSTALL ALL TEMPORARY SEDIMENT AND EROSION CONTROL MEASURES IN LOCATIONS AS SHOWN ON THE CONTRACT DRAWINGS. NO CONSTRUCTION OR LAND DISTURBANCE ACTIVITIES MAY BEGIN UNTIL ALL TEMPORARY SEDIMENT AND EROSION CONTROL MEASURES HAVE BEEN INSTALLED.
- 4. ONCE ALL TEMPORARY EROSION CONTROL MEASURES HAVE BEEN INSTALLED, CONSTRUCTION ACTIVITIES MAY BEGIN.
- 5. ALL EXCESS SOIL RESULTING FROM EARTHWORK OPERATIONS NECESSARY FOR INSTALLATION OF PIPES AND STRUCTURES SHALL BE REMOVED FROM SITE BY CONTRACTOR. ANY SOILS TAKEN OFFSITE BECOMES THE CONTRACTORS RESPONSIBILITY, AND SHALL COMPLY WITH ALL REQUIRED STATE AND LOCAL REGULATIONS AND PERMITS.
- 6. ALL PIPE WORK SHALL BE INSTALLED IN ACCORDANCE WITH STANDARD CONSTRUCTION TECHNIQUES ONLY THE LENGTH OF TRENCH IN WHICH PIPE CAN BE INSTALLED IN ONE DAYS TIME SHALL BE OPEN AT ANY TIME, WITH SPOIL MATERIAL PLACED ON THE UPHILL SIDE OF THE TRENCH. TRENCH SHALL BE BACKFILLED AT END OF EACH DAYS WORK AND DISTURBED AREA SEEDED WITH TEMPORARY SEEDING MEASURES IF APPROPRIATE.
- 7. TEMPORARY SEEDING MEASURES SHALL BE EMPLOYED AS SOON AS PRACTICABLE ON DISTURBED AREAS BUT IN ANY EVENT WITHIN FOURTEEN (14) DAYS. DISTURBED SLOPES STEEPER THAN 3:1 SHALL BE TEMPORARILY SEEDED WITHIN SEVEN (7) DAYS UNLESS SLOPE LENGTH IS TEN (10) FEET OR LESS AND NOT STEEPER THAN 2:1. DISTURBED SLOPES 3:1 OR FLATTER SHALL BE TEMPORARILY SEEDED WITHIN FOURTEEN (14) DAYS UNLESS SLOPE LENGTH IS GREATER THAN 50 FEET.
- 8. STORM DRAINAGE INLETS SHALL BE PROTECTED WITH APPROPRIATE EROSION CONTROL MEASURES AT ALL TIMES.
- ONCE ALL EARTHWORK AND CONSTRUCTION ACTIVITIES ARE COMPLETE, FINAL GRADING MAY BEGIN.
- 10. UPON COMPLETION OF FINAL GRADING, PERMANENT SEEDING SHALL BE APPLIED ON ALL DISTURBED AREAS. VEGETATIVE GROUND COVER SHALL BE APPLIED ON ALL DISTURBED AREAS AS OUTLINED IN NOTE 7, ABOVE. PERMANENT GROUNDCOVER SHALL BE ESTABLISHED IN 90 CALENDAR DAYS. HOWEVER, NPDES GROUNDCOVER REQUIREMENTS TAKE PRECEDENCE.
- 11. ONCE PERMANENT STABILIZATION HAS OCCURRED, AND APPROVAL OF THE STATE LAND QUALITY SECTION ((919) 791-4200) HAS BEEN GRANTED, TEMPORARY SEDIMENT CONTROL MEASURES MAY BE REMOVED. ANY AREAS DISTURBED BY THE REMOVAL OF THESE MEASURES SHALL BE RETURNED TO ORIGINAL OR BETTER CONDITION AND SEEDED, MULCHED, AND FERTILIZED.
- 12. WHEN THE PROJECT IS COMPLETE, THE PERMITTEE SHALL CONTACT DEMLR TO CLOSE OUT THE E&SC PLAN. AFTER DEMLR INFORMS THE PERMITTEE OF THE PROJECT CLOSE OUT, VIA INSPECTION REPORT THE PERMITTEE SHALL VISIT DEQ.NC.GOV/NCG01 TO SUBMIT AN ELECTRONIC NOTICE OF INTENT (E-NOT). A \$100 ANNUAL GENERAL PERMIT FEE WILL BE CHARGED UNTIL THE E-NOT HAS BEEN FILLED OUT.

**GENERAL** 

HAZEN NO.:

31187-003 CONTRACT NO. **DRAWING** 

NUMBER:

G3

JANUARY 2022

ISSUED FOR

DESIGNED BY: C. WILSON S. KANE DRAWN BY: M. SANTOWASSO CHECKED BY F THIS BAR DOES NOT MEASURE 1" THEN DRAWING IS NOT TO FULL SCALE

FINAL DESIGN -DO NOT USE FOR CONSTRUCTION

K. BRAY


044600 Digitally signed by Winne Wilson Date: 2021.12.28 15:02:28-05'00


CEDAR LANE DRAINAGE

CITY OF GREENVILLE

GREENVILLE, NORTH CAROLINA

**GENERAL NOTES IMPROVEMENTS** 

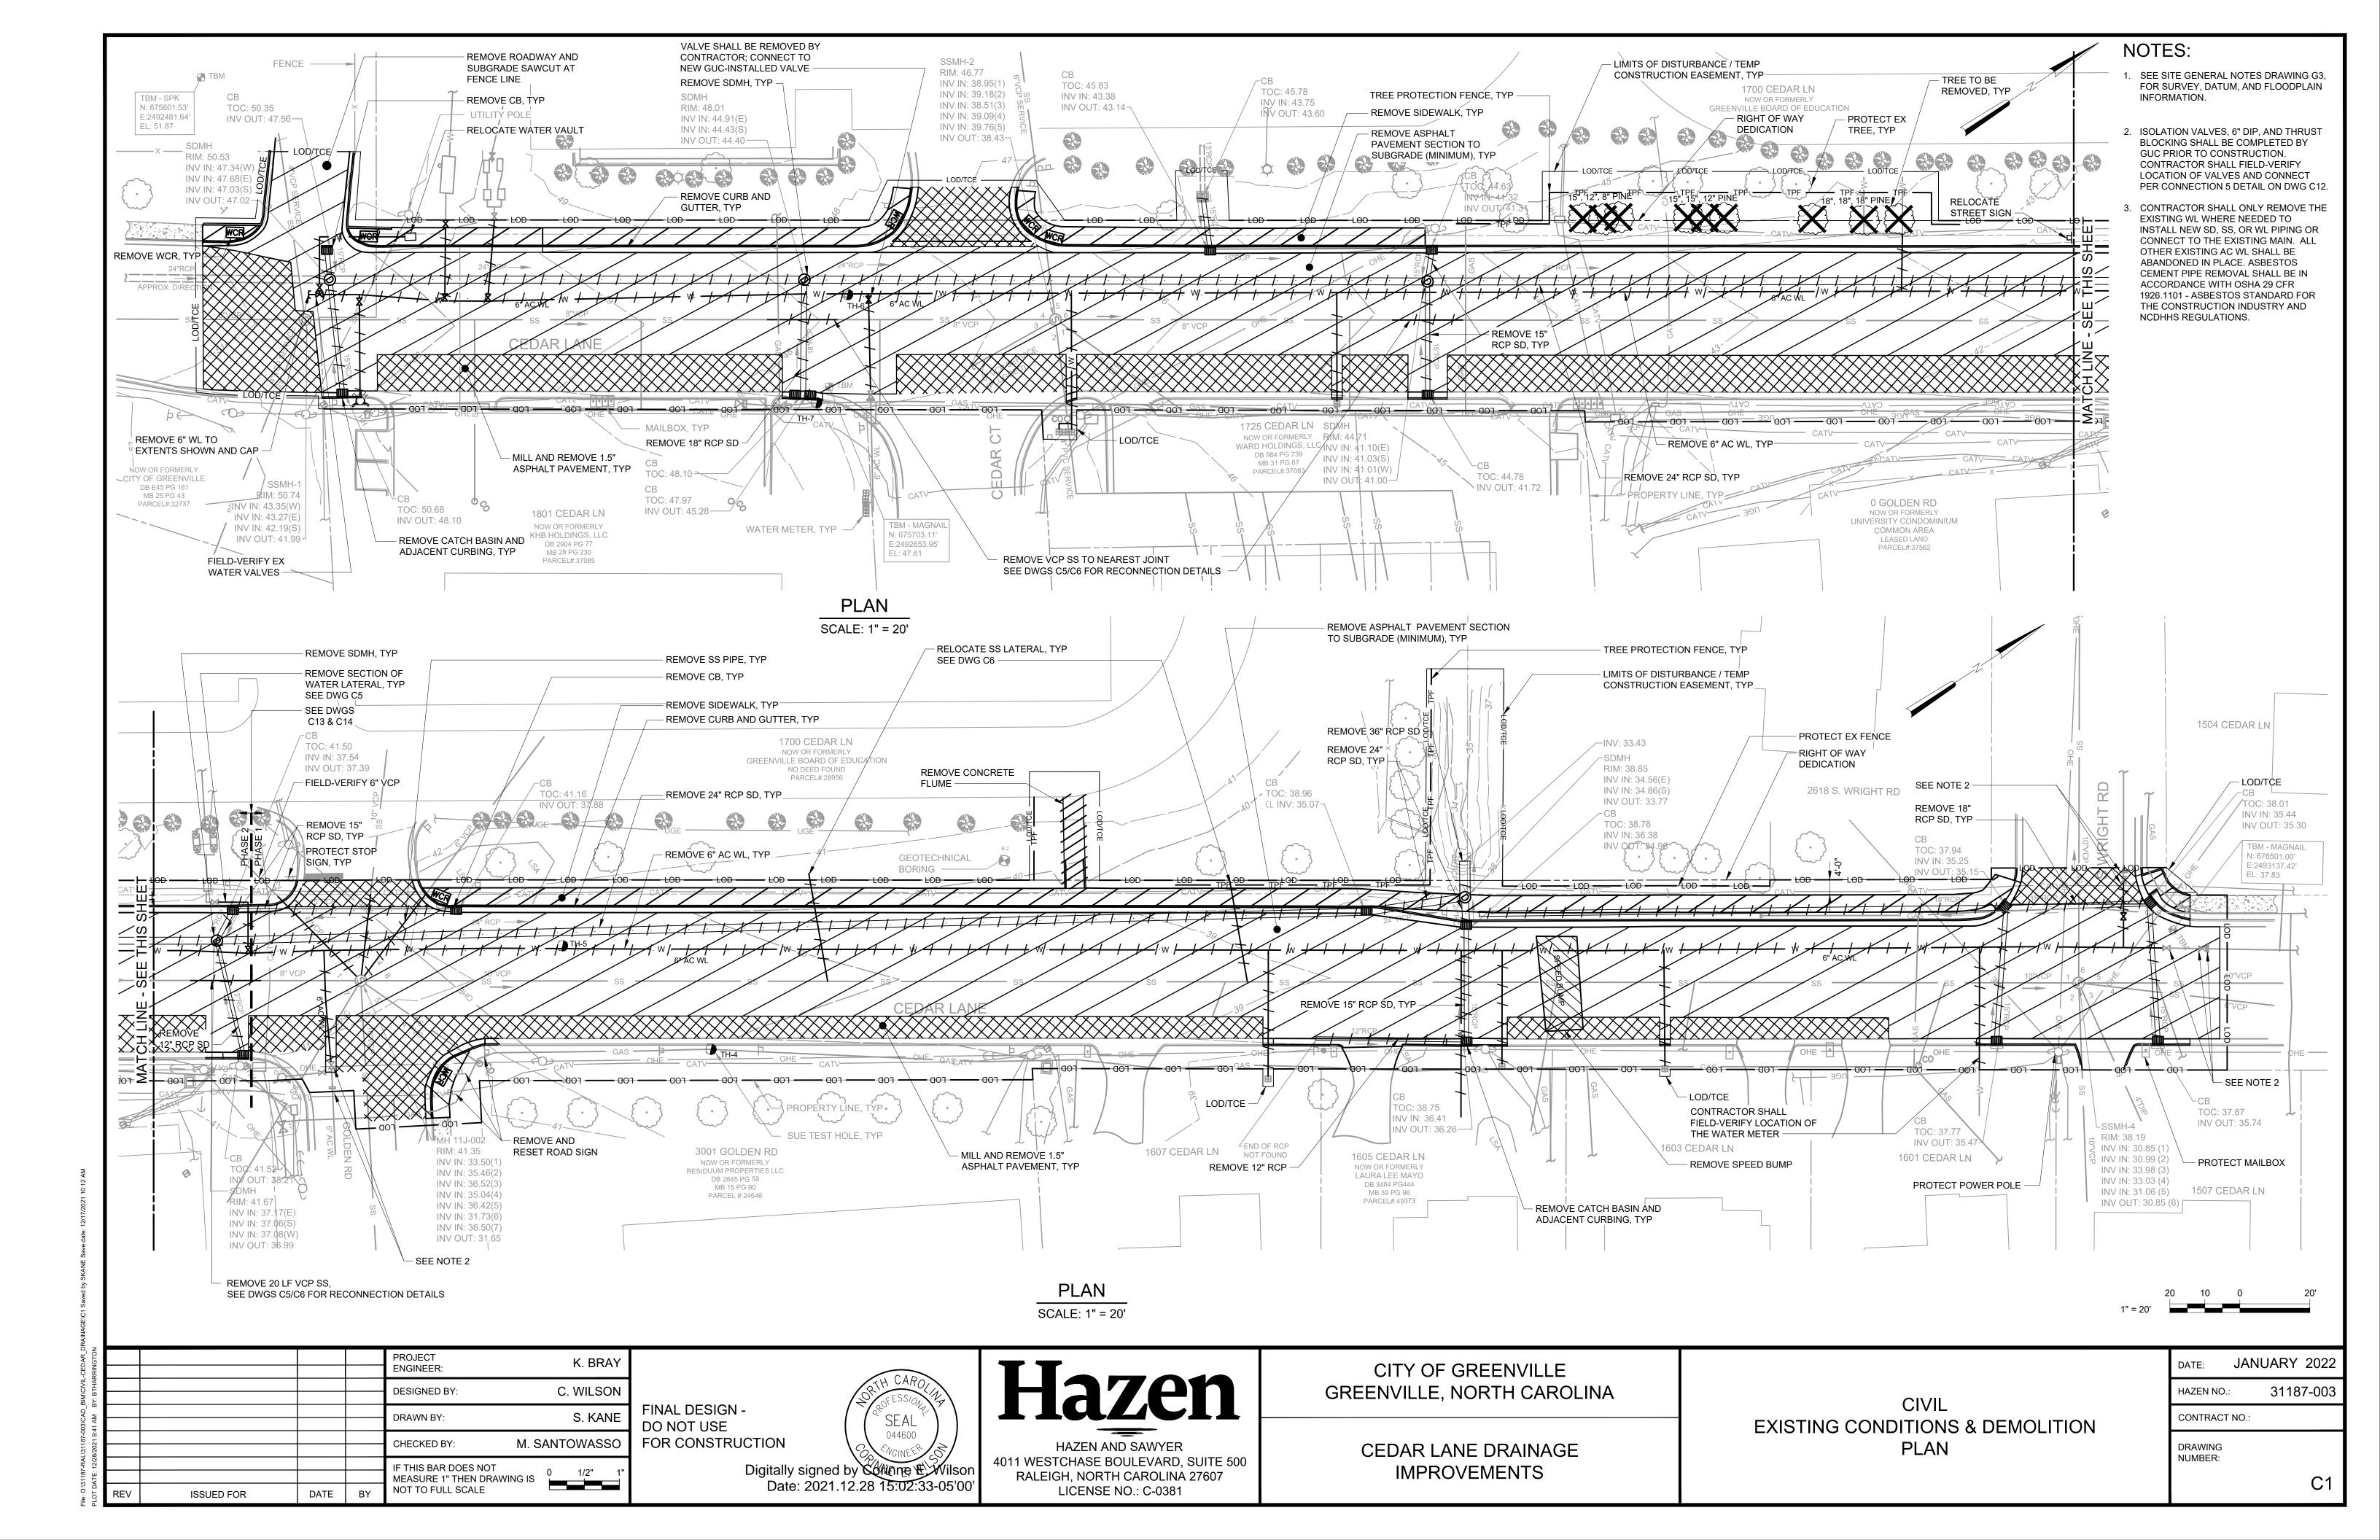

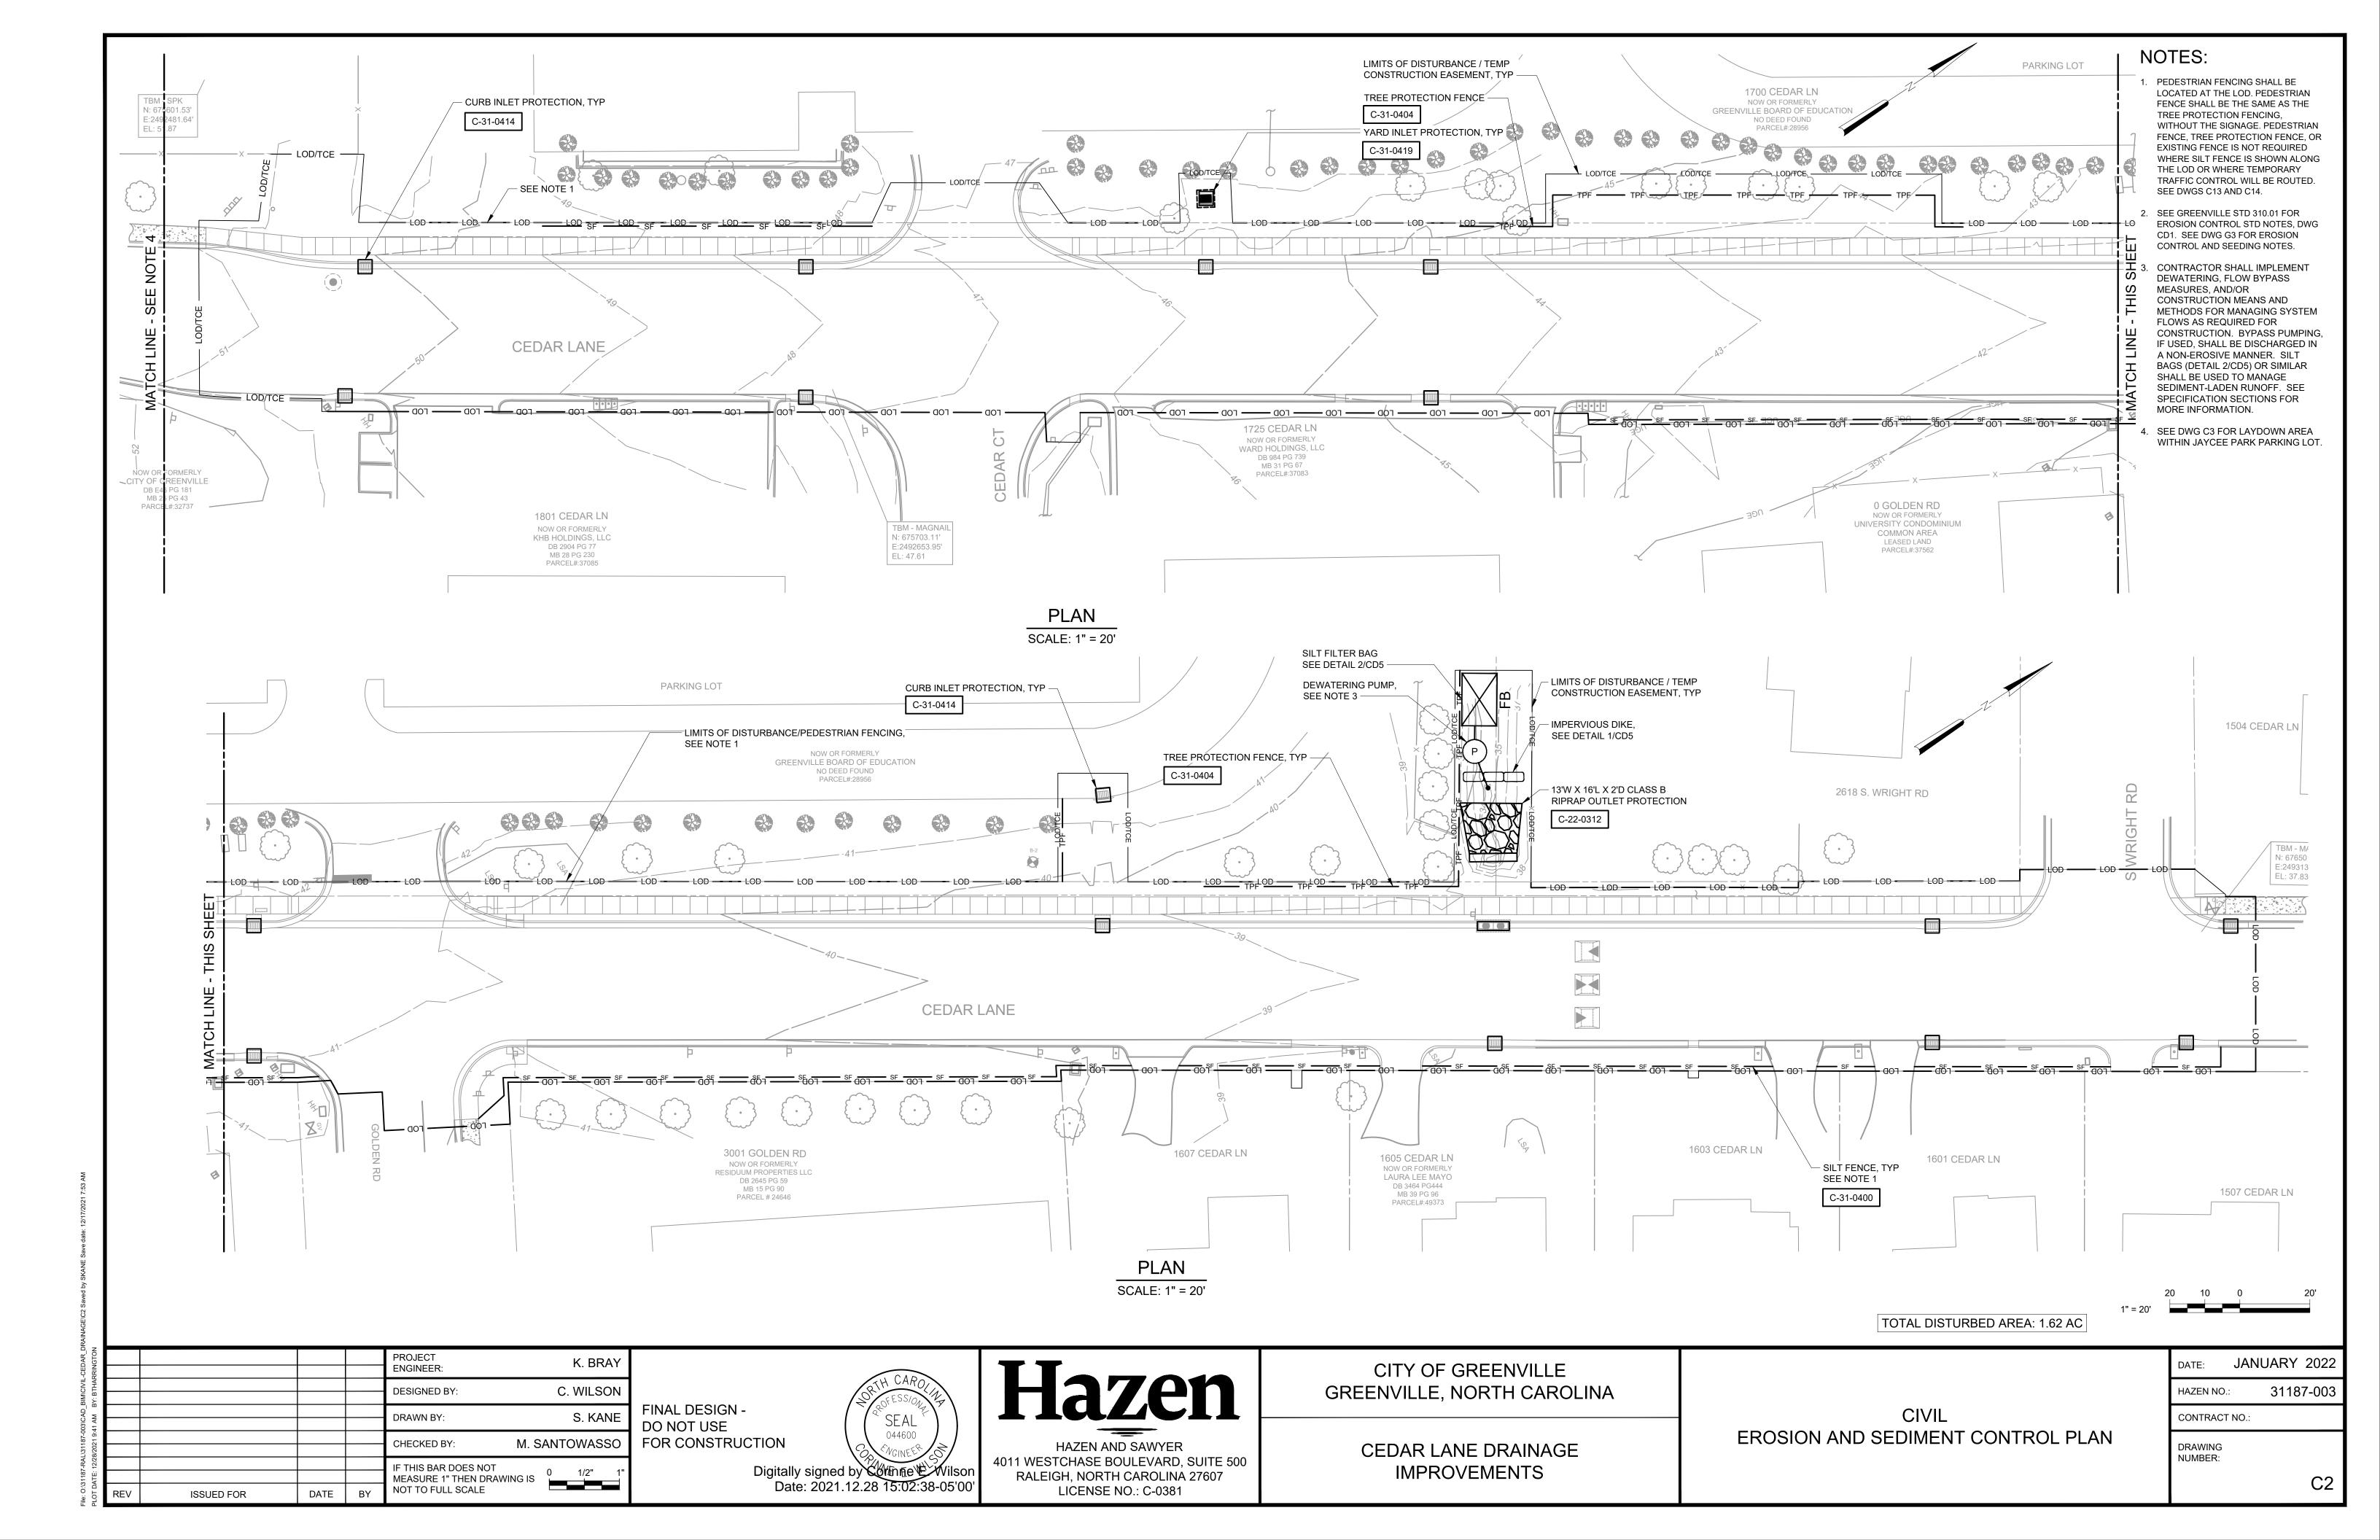

# GROUND STABILIZATION AND MATERIALS HANDLING PRACTICES FOR COMPLIANCE WITH THE NCG01 CONSTRUCTION GENERAL

IMPLEMENTING THE DETAILS AND SPECIFICATIONS ON THIS PLAN SHEET WILL RESULT IN THE CONSTRUCTION ACTIVITY BEING CONSIDERED COMPLIANT WITH THE GROUND STABILIZATION AND MATERIALS HANDLING SECTIONS OF NCG01 CONSTRUCTION GENERAL PERMIT (SECTIONS E AND F, RESPECTIVELY). THE PERMITTEE SHALL COMPLY WITH THE EROSION AND SEDIMENT CONTROL PLAN APPROVED BY THE DELEGATED AUTHORITY HAVING JURISDICTION. ALL DETAILS AND SPECIFICATIONS SHOWN ON THIS SHEET MAY NOT APPLY DEPENDING ON SITE CONDITIONS AND THE DELEGATED AUTHORITY HAVING JURISDICTION.

#### SECTION E: GROUND STABILIZATION

REQUIR	ED GROUND STABILIZATION	ON TIMEFRAMES
SITE AREA DESCRIPTION  SITE AREA DESCRIPTION  AFTER CEASING LAND DISTURBANCE		TIME FRAME VARIATIONS
(A) PERIMETER DIKES, SWALES, DITCHES, AND PERIMETER SLOPES	7	NONE
(B) HIGH WATER QUALITY (HQW) ZONES	7	NONE
(C) SLOPES STEEPER THAN 3:1	7	IF SLOPES ARE 10' OR LESS IN LENGTH AND ARE NOT STEEPER THAN 2:1, 14 DAYS ARE ALLOWED
(D) SLOPES 3:1 TO 4:1	14	-7 DAYS FOR SLOPES GREATER THAN 50' IN LENGTH AND WITH SLOPES STEEPER THAN 4:1 -7 DAYS FOR PERIMETER DIKES, SWALES, DITCHES, PERIMETER SLOPES AND HQW ZONES -10 DAYS FOR FALLS LAKE WATERSHED
(E) AREAS WITH SLOPES FLATTER THAN 4:1	14	-7 DAYS FOR PERIMETER DIKES, SWALES, DITCHES, PERIMETER SLOPES, AND HQW ZONES -10 DAYS FOR FALLS LAKE WATERSHED UNLESS THERE IS ZERO SLOPE

**NOTE:** AFTER THE PERMANENT CESSATION OF CONSTRUCTION ACTIVITIES, ANY AREAS WITH TEMPORARY GROUND STABILIZATION SHALL BE CONVERTED TO PERMANENT GROUND STABILIZATION AS SOON AS PRACTICABLE BUT IN NO CASE LONGER THAN 90 CALENDAR DAYS AFTER THE LAST LAND DISTURBING ACTIVITY. TEMPORARY GROUND STABILIZATION SHALL BE MAINTAINED IN A MANNER TO RENDER THE SURFACE STABLE AGAINST ACCELERATED EROSION UNTIL PERMANENT GROUND STABILIZATION IS ACHIEVED.

#### **GROUND STABILIZATION SPECIFICATION**

STABILIZE THE GROUND SUFFICIENTLY SO THAT RAIN WILL NOT DISLODGE THE SOIL. USE ONE OF THE TECHNIQUES IN THE TABLE BELOW:

- TEMPORARY STABILIZATION

  TEMPORARY GRASS SEED COVERED
  WITH STRAW OR OTHER MULCHES AND
  TACKIFIERS

  HYDROSEEDING
  ROLLED EROSION CONTROL PRODUCTS
  WITH OR WITHOUT TEMPORARY GRASS
  SEED
  APPROPRIATELY APPLIED STRAW OR
  OTHER MULCH
  PLASTIC SHEETING

  PER
  STR
  TAC
  GEC
  PER
  MAT
  SHR
  PLAI
  UNIF
- PERMANENT STABILIZATION

  PERMANENT GRASS SEED COVERED WITH STRAW OR OTHER MULCHES AND TACKIFIERS
  GEOTEXTILE FABRICS SUCH AS PERMANENT SOIL REINFORCEMENT MATTING
  HYDROSEEDING
  SHRUBS OR OTHER PERMANENT PLANTINGS COVERED WITH MULCH
  UNIFORM AND EVENLY DISTRIBUTED GROUND COVER SUFFICIENT TO RESTRAIN FROSION

STRUCTURAL METHODS SUCH AS

WITH GRASS SEED

CONCRETE, ASPHALT OR RETAINING

ROLLED EROSION CONTROL PRODUCTS

#### EQUIPMENT AND VEHICLE MAINTENANCE

- MAINTAIN VEHICLES AND EQUIPMENT TO PREVENT DISCHARGE OF FLUIDS.
   PROVIDE DRIP PANS UNDER ANY STORED EQUIPMENT.
- . IDENTIFY LEAKS AND REPAIR AS SOON AS FEASIBLE, OR REMOVE LEAKING EQUIPMENT FROM THE PROJECT.
- 4. COLLECT ALL SPENT FLUIDS, STORE IN SEPARATE CONTAINERS AND PROPERLY DISPOSE AS HAZARDOUS WASTE (RECYCLE WHEN POSSIBLE).

REMOVE LEAKING VEHICLES AND CONSTRUCTION EQUIPMENT FROM SERVICE

UNTIL THE PROBLEM HAS BEEN CORRECTED.

6. BRING USED FUELS, LUBRICANTS, COOLANTS, HYDRAULIC FLUIDS AND OTHER PETROLEUM PRODUCTS TO A RECYCLING OR DISPOSAL CENTER THAT HANDLES THESE MATERIALS.

#### LITTER, BUILDING MATERIAL AND LAND CLEARING WASTE

- . NEVER BURY OR BURN WASTE. PLACE LITTER AND DEBRIS IN APPROVED WASTE
- CONTAINERS.
  PROVIDE A SUFFICIENT NUMBER AND SIZE OF WASTE CONTAINERS (E.G DUMPSTER, TRASH RECEPTACLE) ON SITE TO CONTAIN CONSTRUCTION AND
- DOMESTIC WASTES.

  3. LOCATE WASTE CONTAINERS AT LEAST 50 FEET AWAY FROM STORM DRAIN INLETS AND SURFACE WATERS UNLESS NO OTHER ALTERNATIVES ARE
- REASONABLY AVAILABLE.

  4. LOCATE WASTE CONTAINERS ON AREAS THAT DO NOT RECEIVE SUBSTANTIAL AMOUNTS OF RUNOFF FROM UPLAND AREAS AND DOES NOT DRAIN DIRECTLY TO
- A STORM DRAIN, STREAM OR WETLAND.

  5. COVER WASTE CONTAINERS AT THE END OF EACH WORKDAY AND BEFORE STORM EVENTS OR PROVIDE SECONDARY CONTAINMENT. REPAIR OR REPLACE
- DAMAGED WASTE CONTAINERS.

  6. ANCHOR ALL LIGHTWEIGHT ITEMS IN WASTE CONTAINERS DURING TIMES OF HIGH
- 7. EMPTY WASTE CONTAINERS AS NEEDED TO PREVENT OVERFLOW. CLEAN UP IMMEDIATELY IF CONTAINERS OVERFLOW.
- 8. DISPOSE WASTE OFF-SITE AT AN APPROVED DISPOSAL FACILITY.
- 9. ON BUSINESS DAYS, CLEAN UP AND DISPOSE OF WASTE IN DESIGNATED WASTE CONTAINERS.

#### PAINT AND OTHER LIQUID WASTE

- 1. DO NOT DUMP PAINT AND OTHER LIQUID WASTE INTO STORM DRAINS, STREAMS
- 2. LOCATE PAINT WASHOUTS AT LEAST 50 FEET AWAY FROM STORM DRAIN INLETS AND SURFACE WATERS UNLESS NO OTHER ALTERNATIVES ARE REASONABLY AVAILABLE.
- 3. CONTAIN LIQUID WASTES IN A CONTROLLED AREA.
- 4. CONTAINMENT MUST BE LABELED, SIZED AND PLACED APPROPRIATELY FOR THE NEEDS OF SITE.
- 5. PREVENT THE DISCHARGE OF SOAPS, SOLVENTS, DETERGENTS AND OTHER LIQUID WASTES FROM CONSTRUCTION SITES.

#### PORTABLE TOILETS

- INSTALL PORTABLE TOILETS ON LEVEL GROUND, AT LEAST 50 FEET AWAY FROM STORM DRAINS, STREAMS OR WETLANDS UNLESS THERE IS NO ALTERNATIVE REASONABLY AVAILABLE. IF 50 FOOT OFFSET IS NOT ATTAINABLE, PROVIDE RELOCATION OF PORTABLE TOILET BEHIND SILT FENCE OR PLACE ON A GRAVEL PAD AND SURROUND WITH SAND BAGS.
- 2. PROVIDE STAKING OR ANCHORING OF PORTABLE TOILETS DURING PERIODS OF HIGH WINDS OR IN HIGH FOOT TRAFFIC AREAS.
- 3. MONITOR PORTABLE TOILETS FOR LEAKING AND PROPERLY DISPOSE OF ANY LEAKED MATERIAL. UTILIZE A LICENSED SANITARY WASTE HAULER TO REMOVE LEAKING PORTABLE TOILETS AND REPLACE WITH PROPERLY OPERATING UNIT.

#### **EARTHEN STOCKPILE MANAGEMENT**

- 1. SHOW STOCKPILE LOCATIONS ON PLANS. LOCATE EARTHEN-MATERIAL STOCKPILE AREAS AT LEAST 50 FEET AWAY FROM STORM DRAIN INLETS, SEDIMENT BASINS, PERIMETER SEDIMENT CONTROLS AND SURFACE WATERS UNLESS IT CAN BE SHOWN NO OTHER ALTERNATIVES ARE REASONABLY AVAILABLE.
- PROTECT STOCKPILE WITH SILT FENCE INSTALLED ALONG TOE OF SLOPE WITH A MINIMUM OFFSET OF FIVE FEET FROM THE TOE OF STOCKPILE.
   PROVIDE STABLE STONE ACCESS POINT WHEN FEASIBLE.
- STABILIZE STOCKPILE WITHIN THE TIMEFRAMES PROVIDED ON THIS SHEET AND IN ACCORDANCE WITH THE APPROVED PLAN AND ANY ADDITIONAL REQUIREMENTS. SOIL STABILIZATION IS DEFINED AS VEGETATIVE, PHYSICAL OR CHEMICAL COVERAGE TECHNIQUES THAT WILL RESTRAIN ACCELERATED EROSION ON DISTURBED SOILS FOR TEMPORARY OR PERMANENT CONTROL NEEDS.

#### **ONSITE CONCRETE WASHOUT STRUCTURE WITH LINER** 10' MIN SANDBAGS (TYP) OR STAPLES HIGH COHESIVE & LOW FILTRATION SOIL BERM 10 MIL PLASTIC SAND BAGS (TYP) LINING OR STAPLES 1:1 SIDE SLOPE SILT FENCE SANDBAGS (TYP) OR STAPLES HIGH COHESIVE & LOW FILTRATION SOIL BERM 10 MIL PLASTIC LINING SLOPES (TYP) **SECTION A-A SECTION B-B** SANDBAGS (TYP) OR STAPLES CLEARLY MARKED SIGNAGE PLAN NOTING DEVICE (18" X 24" MIN) 1. ACTUAL LOCATION DETERMINED IN FIELD. **CLEARLY MARKED SIGNAGE CONCRETE** NOTING DEVICE (18" X 24" MIN) 2. THE CONCRETE WASHOUT STRUCTURES SHALL BE WASHOUT MAINTAINED WHEN THE LIQUID AND/OR SOLID REACHES 75% OF CONCRETE THE STRUCTURES CAPACITY. WASHOUT 1. ACTUAL LOCATION DETERMINED IN FIELD. 3.CONCRETE WASHOUT STRUCTURE NEEDS TO BE CLEARY MARKED WITH SIGNAGE NOTING DEVICE. 2. THE CONCRETE WASHOUT STRUCTURES SHALL BE MAINTAINED WHEN THE LIQUID AND/OR SOLID REACHES 75% OF THE STRUCTURES CAPACITY TO PROVIDE ADEQUATE HOLDING CAPACITY WITH A MINIMUM 12 INCHES OF FREEBOARD. BELOW GRADE WASHOUT STRUCTURE NOT TO SCALE 3.CONCRETE WASHOUT STRUCTURE NEEDS TO BE CLEARY

#### CONCRETE WASHOUTS

- DO NOT DISCHARGE CONCRETE OR CEMENT SLURRY FROM THE SITE.
   DISPOSE OF, OR RECYCLE SETTLED, HARDENED CONCRETE RESIDUE IN ACCORDANCE WITH
- LOCAL AND STATE SOLID WASTE REGULATIONS AND AT AN APPROVED FACILITY.


  MANAGE WASHOUT FROM MORTAR MIXERS IN ACCORDANCE WITH THE AROVE ITEM AND
- MANAGE WASHOUT FROM MORTAR MIXERS IN ACCORDANCE WITH THE ABOVE ITEM AND IN ADDITION PLACE THE MIXER AND ASSOCIATED MATERIALS ON IMPERVIOUS BARRIER AND WITHIN LOT PERIMETER SILT FENCE.
- 4. INSTALL TEMPORARY CONCRETE WASHOUTS PER LOCAL REQUIREMENTS, WHERE APPLICABLE. IF AN ALTERNATE METHOD OR PRODUCT IS TO BE USED, CONTACT YOUR APPROVAL AUTHORITY FOR REVIEW AND APPROVAL. IF LOCAL STANDARD DETAILS ARE NOT AVAILABLE, USE ONE OF THE TWO TYPES OF TEMPORARY CONCRETE WASHOUTS PROVIDED ON THIS DETAIL
- 5. DO NOT USE CONCRETE WASHOUTS FOR DEWATERING OR STORING DEFECTIVE CURB OR SIDEWALK SECTIONS. STORMWATER ACCUMULATED WITHIN THE WASHOUT MAY NOT BE PUMPED INTO OR DISCHARGED TO THE STORM DRAIN SYSTEM OR RECEIVING SURFACE WATERS. LIQUID WASTE MUST BE PUMPED OUT AND REMOVED FROM PROJECT.
- LOCATE WASHOUTS AT LEAST 50 FEET FROM STORM DRAIN INLETS AND SURFACE WATERS
   UNLESS IT CAN BE SHOWN THAT NO OTHER ALTERNATIVES ARE REASONABLY AVAILABLE. AT
   A MINIMUM, INSTALL PROTECTION OF STORM DRAIN INLET(S) CLOSEST TO THE WASHOUT
   WHICH COULD RECEIVE SPILLS OR OVERFLOW.
- 7. LOCATE WASHOUTS IN AN EASILY ACCESSIBLE AREA, ON LEVEL GROUND AND INSTALL A STONE ENTRANCE PAD IN FRONT OF THE WASHOUT. ADDITIONAL CONTROLS MAY BE REQUIRED BY THE APPROVING AUTHORITY.
- INSTALL AT LEAST ONE SIGN DIRECTING CONCRETE TRUCKS TO THE WASHOUT WITHIN THE PROJECT LIMITS. POST SIGNAGE ON THE WASHOUT ITSELF TO IDENTIFY THIS LOCATION.
   REMOVE LEAVINGS FROM THE WASHOUT WHEN AT APPROXIMATELY 75% CAPACITY TO LIMIT OVERFLOW EVENTS. REPLACE THE TARP, SAND BAGS OR OTHER TEMPORARY STRUCTURAL COMPONENTS WHEN NO LONGER FUNCTIONAL. WHEN UTILIZING ALTERNATIVE OR
- PROPRIETARY PRODUCTS, FOLLOW MANUFACTURER'S INSTRUCTIONS.

  10. AT THE COMPLETION OF THE CONCRETE WORK, REMOVE REMAINING LEAVINGS AND DISPOSE OF IN AN APPROVED DISPOSAL FACILITY. FILL PIT, IF APPLICABLE, AND STABILIZE ANY DISTURBANCE CAUSED BY REMOVAL OF WASHOUT.

#### HERBICIDES, PESTICIDES AND RODENTICIDES

- STORE AND APPLY HERBICIDES, PESTICIDES AND RODENTICIDES IN ACCORDANCE WITH LABEL RESTRICTIONS.
- 2. STORE HERBICIDES, PESTICIDES AND RODENTICIDES IN THEIR ORIGINAL CONTAINERS WITH THE LABEL, WHICH LISTS DIRECTIONS FOR USE, INGREDIENTS AND FIRST AID STEPS IN CASE OF ACCIDENTAL POISONING.
- 3. DO NOT STORE HERBICIDES, PESTICIDES AND RODENTICIDES IN AREAS WHERE FLOODING IS POSSIBLE OR WHERE THEY MAY SPILL OR LEAK INTO WELLS, STORMWATER DRAINS, GROUND WATER OR SURFACE WATER. IF A SPILL OCCURS, CLEAN AREA IMMEDIATELY.
- 4. DO NOT STOCKPILE THESE MATERIALS ONSITE.

- HAZARDOUS AND TOXIC WASTE1. CREATE DESIGNATED HAZARDOUS WASTE COLLECTION AREAS ON-SITE.
- PLACE HAZARDOUS WASTE CONTAINERS UNDER COVER OR IN SECONDARY CONTAINMENT.
   DO NOT STORE HAZARDOUS CHEMICALS, DRUMS OR BAGGED MATERIALS DIRECTLY ON THE

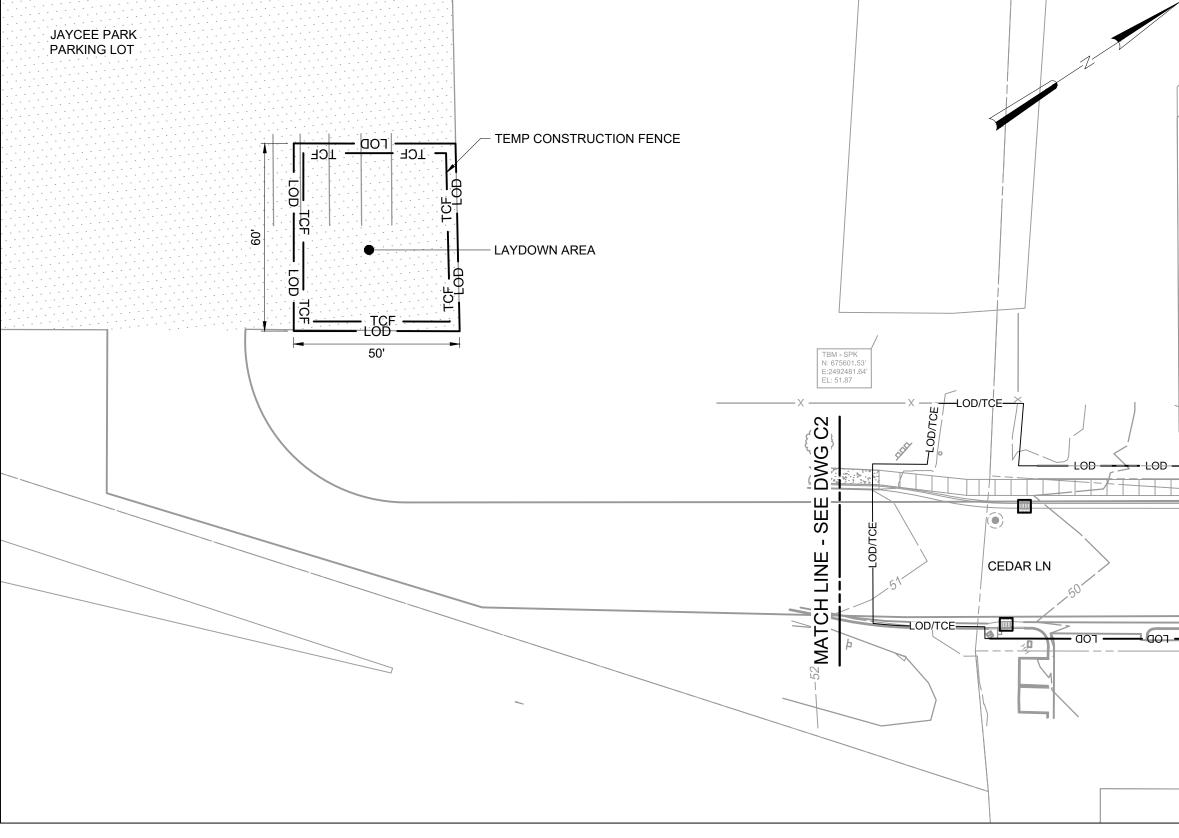

ABOVE GRADE WASHOUT STRUCTURE

MARKED WITH SIGNAGE NOTING DEVICE.

# PROJECT ENGINEER: DESIGNED BY: C. WILSON DRAWN BY: S. KANE CHECKED BY: M. SANTOWASSO IF THIS BAR DOES NOT MEASURE 1" THEN DRAWING IS NOT TO FULL SCALE REV ISSUED FOR DATE BY K. BRAY K. BRAY DESIGNED BY: C. WILSON DRAWN BY: S. KANE O 1/2" 1" MEASURE 1" THEN DRAWING IS NOT TO FULL SCALE

FINAL DESIGN -DO NOT USE FOR CONSTRUCTION

CTION

Digitally signed by Comme Wilson

Date: 2021.12.28 15:02:43-05'00'



RALEIGH, NORTH CAROLINA 27607

LICENSE NO.: C-0381

CITY OF GREENVILLE GREENVILLE, NORTH CAROLINA

CEDAR LANE DRAINAGE IMPROVEMENTS

CIVIL GROUND STABILIZATION, MATERIALS HANDLING, AND LAYDOWN AREA

DATE:	JANUARY 2022
HAZEN NO.:	31187-003
CONTRACT	NO.:
DRAWING NUMBER:	
	C3

# PART II, SECTION G, ITEM (4)

#### DRAW DOWN OF SEDIMENT BASINS FOR MAINTENANCE OR CLOSE OUT

SEDIMENT BASINS AND TRAPS THAT RECEIVE RUNOFF FROM DRAINAGE AREAS OF ONE ACRE OR MORE SHALL USE OUTLET STRUCTURES THAT WITHDRAW WATER FROM THE SURFACE WHEN THESE DEVICES NEED TO BE DRAWN DOWN FOR MAINTENANCE OR CLOSE OUT UNLESS THIS IS INFEASIBLE. THE CIRCUMSTANCES IN WHICH IT IS NOT FEASIBLE TO WITHDRAW WATER FROM THE SURFACE SHALL BE RARE (FOR EXAMPLE, TIMES WITH EXTENDED COLD WEATHER). NON-SURFACE WITHDRAWALS FROM SEDIMENT BASINS SHALL BE ALLOWED ONLY WHEN ALL OF THE FOLLOWING CRITERIA HAVE BEEN MET:

- (A) THE E&SC PLAN AUTHORITY HAS BEEN PROVIDED WITH DOCUMENTATION OF THE NON-SURFACE WITHDRAWAL AND THE SPECIFIC TIME PERIODS OR CONDITIONS IN WHICH IT WILL OCCUR. THE NON-SURFACE WITHDRAWAL
- SHALL NOT COMMENCE UNTIL THE E&SC PLAN AUTHORITY HAS APPROVED THESE ITEMS,
- (B) THE NON-SURFACE WITHDRAWAL HAS BEEN REPORTED AS AN ANTICIPATED BYPASS IN ACCORDANCE WITH PART III, SECTION C, ITEM (2)(C) AND (D) OF THIS PERMIT,
- (C) DEWATERING DISCHARGES ARE TREATED WITH CONTROLS TO MINIMIZE DISCHARGES OF POLLUTANTS FROM STORMWATER THAT IS REMOVED FROM THE SEDIMENT BASIN. EXAMPLES OF APPROPRIATE CONTROLS PROPERLY SITED, DESIGNED AND MAINTAINED DEWATERING TANKS, WEIR TANKS, AND FILTRATION SYSTEMS,
- VEGETATED, UPLAND AREAS OF THE SITES OR A PROPERLY DESIGNED STONE PAD IS USED TO THE EXTENT FEASIBLE AT THE OUTLET OF THE DEWATERING TREATMENT DEVICES DESCRIBED IN ITEM (C) ABOVE,
- VELOCITY DISSIPATION DEVICES SUCH AS CHECK DAMS, SEDIMENT TRAPS, AND RIPRAP ARE PROVIDED AT THE DISCHARGE POINTS OF ALL DEWATERING DEVICES, AND
- SEDIMENT REMOVED FROM THE DEWATERING TREATMENT DEVICES DESCRIBED IN ITEM (C) ABOVE IS DISPOSED OF IN A MANNER THAT DOES NOT CAUSE DEPOSITION OF SEDIMENT INTO WATERS OF THE UNITED STATES.

#### PART III SELF-INSPECTION, RECORDKEEPING AND REPORTING

#### SECTION A: SELF-INSPECTION

SELF-INSPECTIONS ARE REQUIRED DURING NORMAL BUSINESS HOURS IN ACCORDANCE WITH THE TABLE BELOW. WHEN ADVERSE WEATHER OR SITE CONDITIONS WOULD CAUSE THE SAFETY OF THE INSPECTION PERSONNEL TO BE IN JEOPARDY, THE INSPECTION MAY BE DELAYED UNTIL THE NEXT BUSINESS DAY ON WHICH IT IS SAFE TO PERFORM THE INSPECTION. IN ADDITION, WHEN A STORM EVENT OF EQUAL TO OR GREATER THAN 1.0 INCH OCCURS OUTSIDE OF NORMAL BUSINESS HOURS, THE SELF-INSPECTION SHALL BE PERFORMED UPON THE COMMENCEMENT OF THE NEXT BUSINESS DAY. ANY TIME WHEN INSPECTIONS WERE DELAYED SHALL BE NOTED IN THE INSPECTION RECORD.

	REQUIRED GROUND ST	ABILIZATION TIMEFRAMES
INSPECT	FREQUENCY (DURING NORMAL BUSINESS HOURS)	INSPECTION RECORDS MUST INCLUDE:
(1) RAIN GAUGE MAINTAINED IN GOOD WORKING ORDER	DAILY	DAILY RAINFALL AMOUNTS. IF NO DAILY RAIN GAUGE OBSERVATIONS ARE MADE DURING WEEKEND OR HOLIDAY PERIODS, AND NO INDIVIDUAL-DAY RAINFALL INFORMATION IS AVAILABLE, RECORD THE CUMULATIVE RAIN MEASUREMENT FOR THOSE UN-ATTENDED DAYS (AND THIS WILL DETERMINE IF A SITE INSPECTION IS NEEDED). DAYS ON WHICH NO RAINFALL OCCURRED SHALL BE RECORDED AS "ZERO." THE PERMITTEE MAY USE ANOTHER RAIN-MONITORING DEVICE APPROVED BY THE DIVISION.
(2) E&SC MEASURES	AT LEAST ONCE PER 7 CALENDAR DAYS AND WITHIN 24 HOURS OF A RAIN EVENT ≥ 1.0 INCH IN 24 HOURS	<ol> <li>IDENTIFICATION OF THE MEASURES INSPECTED,</li> <li>DATE AND TIME OF THE INSPECTION,</li> <li>NAME OF THE PERSON PERFORMING THE INSPECTION,</li> <li>INDICATION OF WHETHER THE MEASURES WERE OPERATING PROPERLY,</li> <li>DESCRIPTION OF MAINTENANCE NEEDS FOR THE MEASURE,</li> <li>DESCRIPTION, EVIDENCE, AND DATE OF CORRECTIVE ACTIONS TAKEN.</li> </ol>
(3) STORMWATER DISCHARGE OUTFALLS (SDOS)	AT LEAST ONCE PER 7 CALENDAR DAYS AND WITHIN 24 HOURS OF A RAIN EVENT ≥ 1.0 INCH IN 24 HOURS	<ol> <li>IDENTIFICATION OF THE MEASURES INSPECTED,</li> <li>DATE AND TIME OF THE INSPECTION,</li> <li>NAME OF THE PERSON PERFORMING THE INSPECTION,</li> <li>INDICATION OF WHETHER THE MEASURES WERE OPERATING PROPERLY,</li> <li>DESCRIPTION OF MAINTENANCE NEEDS FOR THE MEASURE,</li> <li>DESCRIPTION, EVIDENCE, AND DATE OF CORRECTIVE ACTIONS TAKEN.</li> </ol>
(4) PERIMETER OF SITE	AT LEAST ONCE PER 7 CALENDAR DAYS AND WITHIN 24 HOURS OF A RAIN EVENT > 1.0 INCH IN 24 HOURS	<ol> <li>IF VISIBLE SEDIMENTATION IS FOUND OUTSIDE SITE LIMITS, THEN A RECORD OF THE FOLLOWING SHALL BE MADE:</li> <li>ACTIONS TAKEN TO CLEAN UP OR STABILIZE THE SEDIMENT THAT HAS LEFT THE SITE LIMITS,</li> <li>DESCRIPTION, EVIDENCE, AND DATE OF CORRECTIVE ACTIONS TAKEN, AND</li> <li>AN EXPLANATION AS TO THE ACTIONS TAKEN TO CONTROL FUTURE RELEASES.</li> </ol>
(5) STREAMS OR WETLANDS ONSITE OR OFFSITE (WHERE ACCESSIBLE)	AT LEAST ONCE PER 7 CALENDAR DAYS AND WITHIN 24 HOURS OF A RAIN EVENT > 1.0 INCH IN 24 HOURS	<ol> <li>IF THE STREAM OR WETLAND HAS INCREASED VISIBLE SEDIMENTATION OR A STREAM HAS VISIBLE INCREASED TURBIDITY FROM THE CONSTRUCTION ACTIVITY, THEN A RECORD OF THE FOLLOWING SHALL BE MADE:</li> <li>DESCRIPTION, EVIDENCE AND DATE OF CORRECTIVE ACTIONS TAKEN, AND</li> <li>RECORDS OF THE REQUIRED REPORTS TO THE APPROPRIATE DIVISION REGIONAL OFFICE PER PART III, SECTION C, ITEM (2)(A) OF THIS PERMIT.</li> </ol>
(6) GROUND STABILIZATION MEASURES	AFTER EACH PHASE OF GRADING	<ol> <li>THE PHASE OF GRADING (INSTALLATION OF PERIMETER E&amp;SC MEASURES, CLEARING AND GRUBBING, INSTALLATION OF STORM DRAINAGE FACILITIES, COMPLETION OF ALL LAND-DISTURBING ACTIVITY, CONSTRUCTION OR REDEVELOPMENT, PERMANENT GROUND COVER).</li> <li>DOCUMENTATION THAT THE REQUIRED GROUND STABILIZATION MEASURES HAVE BEEN PROVIDED WITHIN THE REQUIRED TIMEFRAME OR AN ASSURANCE THAT THEY WILL BE PROVIDED AS SOON AS POSSIBLE.</li> </ol>

#### PART III

#### SELF-INSPECTION, RECORDKEEPING AND REPORTING

#### SECTION B: RECORDKEEPING

#### 1. E&SC PLAN DOCUMENTATION

THE APPROVED E&SC PLAN AS WELL AS ANY APPROVED DEVIATION SHALL BE KEPT ON THE SITE. THE APPROVED E&SC PLAN MUST BE KEPT UP-TO-DATE THROUGHOUT THE COVERAGE UNDER THIS PERMIT. THE FOLLOWING ITEMS PERTAINING TO THE E&SC PLAN SHALL BE KEPT ON SITE AND AVAILABLE FOR INSPECTION AT ALL TIMES DURING NORMAL BUSINESS HOURS.

1		
	ITEM TO DOCUMENT	INSPECTION RECORDS MUST INCLUDE:
	(A) EACH E&SC MEASURE HAS BEEN INSTALLED AND DOES NOT SIGNIFICANTLY DEVIATE FROM THE LOCATIONS, DIMENSIONS AND RELATIVE ELEVATIONS SHOWN ON THE APPROVED E&SC PLAN.	INITIAL AND DATE EACH E&SC MEASURE ON A COPY OF THE APPROVED E&SC PLAN OR COMPLETE, DATE AND SIGN AN INSPECTION REPORT THAT LISTS EACH E&SC MEASURE SHOWN ON THE APPROVED E&SC PLAN. THIS DOCUMENTATION IS REQUIRED UPON THE INITIAL INSTALLATION OF THE E&SC MEASURES OR IF THE E&SC MEASURES ARE MODIFIED AFTER INITIAL INSTALLATION.
	(B) A PHASE OF GRADING HAS BEEN COMPLETED.	INITIAL AND DATE A COPY OF THE APPROVED E&SC PLAN OR COMPLETE, DATE AND SIGN AN INSPECTION REPORT TO INDICATE COMPLETION OF THE CONSTRUCTION PHASE.
	(C) GROUND COVER IS LOCATED AND INSTALLED IN ACCORDANCE WITH THE APPROVED E&SC PLAN.	INITIAL AND DATE A COPY OF THE APPROVED E&SC PLAN OR COMPLETE, DATE AND SIGN AN INSPECTION REPORT TO INDICATE COMPLIANCE WITH APPROVED GROUND COVER SPECIFICATIONS.
	(D) THE MAINTENANCE AND REPAIR REQUIREMENTS FOR ALL E&SC MEASURES HAVE BEEN PERFORMED.	COMPLETE, DATE AND SIGN AN INSPECTION REPORT.
	(E) CORRECTIVE ACTIONS HAVE BEEN TAKEN TO E&SC MEASURES.	INITIAL AND DATE A COPY OF THE APPROVED E&SC PLAN OR COMPLETE, DATE AND SIGN AN INSPECTION REPORT TO INDICATE THE COMPLETION OF THE CORRECTIVE ACTION.

### 2. ADDITIONAL DOCUMENTATION TO BE KEPT ON SITE

IN ADDITION TO THE E&SC PLAN DOCUMENTS ABOVE, THE FOLLOWING ITEMS SHALL BE KEPT ON THE SITE AND AVAILABLE FOR INSPECTORS AT ALL TIMES DURING NORMAL BUSINESS HOURS, UNLESS THE DIVISION PROVIDES A SITE-SPECIFIC EXEMPTION BASED ON UNIQUE SITE CONDITIONS THAT MAKE THIS REQUIREMENT NOT PRACTICAL:

#### (A) THIS GENERAL PERMIT AS WELL AS THE CERTIFICATE OF COVERAGE, AFTER IT IS RECEIVED

(B) RECORDS OF INSPECTIONS MADE DURING THE PREVIOUS TWELVE MONTHS. THE PERMITTEE SHALL RECORD THE REQUIRED OBSERVATIONS ON THE INSPECTION RECORD FORM PROVIDED BY THE DIVISION OR A SIMILAR INSPECTION FORM THAT INCLUDES ALL THE REQUIRED ELEMENTS. USE OF ELECTRONICALLY-AVAILABLE RECORDS IN LIEU OF THE REQUIRED PAPER COPIES WILL BE ALLOWED IF SHOWN TO PROVIDE EQUAL ACCESS AND UTILITY AS THE HARD-COPY RECORDS.

#### 3. DOCUMENTATION TO BE RETAINED FOR THREE YEARS

ALL DATA USED TO COMPLETE THE E-NOI AND ALL INSPECTION RECORDS SHALL BE MAINTAINED FOR A PERIOD OF THREE YEARS AFTER PROJECT COMPLETION AND MADE AVAILABLE UPON REQUEST. [40 CFR

SELF-INSPECTION, RECORDKEEPING AND REPORTING

#### SECTION C: REPORTING

#### OCCURRENCES THAT MUST BE REPORTED

PERMITTEES SHALL REPORT THE FOLLOWING OCCURRENCES:

- (A) VISIBLE SEDIMENT DEPOSITION IN A STREAM OR WETLAND
- (B) OIL SPILLS IF:
- THEY ARE 25 GALLONS OR MORE,
- THEY ARE LESS THAN 25 GALLONS BUT CANNOT BE CLEANED UP WITHIN 24 HOURS,
- THEY CAUSE SHEET ON WATERS (REGARDLESS OF VOLUME), OR
- THEY ARE WITHIN 100 FEET OF SURFACE WATERS (REGARDLESS OF VOLUME).
- (C) RELEASES OF HAZARDOUS SUBSTANCES IN EXCESS OF REPORTABLE QUANTITIES UNDER SECTION 311 OF THE CLEAN WATER ACT (REF: 40 CFR 110.3 AND 40 CFR 117.3) OR SECTION 102 OF CERCLA (REF: 40 CFR 302.4) OR G.S. 143-215.85.
- (D) ANTICIPATED BYPASSES AND UNANTICIPATED BYPASS
- (E) NONCOMPLIANCE WITH THE CONDITIONS OF THIS PERMIT THAT MAY ENDANGER HEALTH OR THE ENVIRONMENT.

#### REPORTING TIMEFRAMES AND OTHER REQUIREMENTS

AFTER A PERMITTEE BECOMES AWARE OF AN OCCURRENCE THAT MUST BE REPORTED, HE SHALL CONTACT THE APPROPRIATE DIVISION REGIONAL OFFICE WITHIN THE TIMEFRAMES AND IN ACCORDANCE WITH THE OTHER REQUIREMENTS LISTED BELOW. OCCURRENCES OUTSIDE NORMAL BUSINESS HOURS MAY ALSO BE REPORTED TO THE DEPARTMENT'S ENVIRONMENTAL EMERGENCY CENTER PERSONNEL AT (800) 858-0368.

OCCURENCE	REPORTING TIMEFRAME (AFTER DISCOVERY) AND OTHER REQUIREMENTS
(A) VISIBLE SEDIMENT DEPOSITION IN A STREAM OR WETLAND	<ul> <li>WITHIN 24 HOURS, AN ORAL OR ELECTRONIC NOTIFICATION.</li> <li>WITHIN 7 CALENDAR DAYS, A REPORT THAT CONTAINS A         DESCRIPTION OF THE SEDIMENT AND ACTIONS TAKEN TO ADDRESS         THE CAUSE OF THE DEPOSITION. DIVISION STAFF MAY WAIVE THE         REQUIREMENT FOR A WRITTEN REPORT ON A CASE-BY-CASE BASIS.</li> <li>IF THE STREAM IS NAMED ON THE NC 303(D) LIST AS IMPAIRED FOR         SEDIMENT-RELATED CAUSES, THE PERMITTEE MAY BE REQUIRED TO         PERFORM ADDITIONAL MONITORING, INSPECTIONS OR APPLY MORE         STRINGENT PRACTICES IF STAFF DETERMINE THAT ADDITIONAL         REQUIREMENTS ARE NEEDED TO ASSURE COMPLIANCE WITH THE         FEDERAL OR STATE IMPAIRED-WATERS CONDITIONS.</li> </ul>
(B) OIL SPILLS AND RELEASE OF HAZARDOUS SUBSTANCES PER ITEM 1(B)-(C) ABOVE	WITHIN 24 HOURS, AN ORAL OR ELECTRONIC NOTIFICATION. THE NOTIFICATION SHALL INCLUDE INFORMATION ABOUT THE DATE, TIME, NATURE, VOLUME AND LOCATION OF THE SPILL OR RELEASE.
(C) ANTICIPATED BYPASSES [40 CFR 122.41(M)(3)]	A REPORT AT LEAST TEN DAYS BEFORE THE DATE OF THE BYPASS, IF POSSIBLE. THE REPORT SHALL INCLUDE AN EVALUATION OF THE ANTICIPATED QUALITY AND EFFECT OF THE BYPASS.
(D) UNANTICIPATED BYPASSES [40 CFR 122.41(M)(3)]	<ul> <li>WITHIN 24 HOURS, AN ORAL OR ELECTRONIC NOTIFICATION.</li> <li>WITHIN 7 CALENDAR DAYS, A REPORT THAT INCLUDES AN EVALUATION OF THE QUALITY AND EFFECT OF THE BYPASS.</li> </ul>
(E) NONCOMPLIANCE WITH THE CONDITIONS OF THIS PERMIT THAT MAY ENDANGER HEALTH OR THE ENVIRONMENT [40 CFR 122.41(L)(7)]	<ul> <li>WITHIN 24 HOURS, AN ORAL OR ELECTRONIC NOTIFICATION.</li> <li>WITHIN 7 CALENDAR DAYS, A REPORT THAT CONTAINS A         DESCRIPTION OF THE NONCOMPLIANCE, AND ITS CAUSES; THE         PERIOD OF NONCOMPLIANCE, INCLUDING EXACT DATES AND TIMES,         AND IF THE NONCOMPLIANCE HAS NOT BEEN CORRECTED, THE         ANTICIPATED TIME NONCOMPLIANCE IS EXPECTED TO CONTINUE;         AND STEPS TAKEN OR PLANNED TO REDUCE, ELIMINATE, AND         PREVENT REOCCURRENCE OF THE NONCOMPLIANCE. [40 CFR         122.41(L)(6).</li> <li>DIVISION STAFF MAY WAIVE THE REQUIREMENT FOR A WRITTEN         REPORT ON A CASE-BY-CASE BASIS.</li> </ul>

				PROJECT K. BRAY
				DESIGNED BY: C. WILSON
				DRAWN BY: S. KANE
				CHECKED BY: M. SANTOWASSO
				IF THIS BAR DOES NOT  MEASURE 1" THEN DRAWING IS  1/2" 1"
REV	ISSUED FOR	DATE	BY	NOT TO FULL SCALE

NOTE: THE RAIN INSPECTION RESETS THE REQUIRED 7 DAY CALENDAR DAY INSPECTION REQUIREMENT

FINAL DESIGN -DO NOT USE FOR CONSTRUCTION



Hazen HAZEN AND SAWYER 4011 WESTCHASE BOULEVARD, SUITE 500 RALEIGH, NORTH CAROLINA 27607

LICENSE NO.: C-0381


CITY OF GREENVILLE GREENVILLE, NORTH CAROLINA


> CEDAR LANE DRAINAGE **IMPROVEMENTS**


CIVIL INSPECTION, RECORDKEEPING AND REPORTING


DATE:	JANUARY 2022
HAZEN NO.	31187-003
CONTRACT	NO.:


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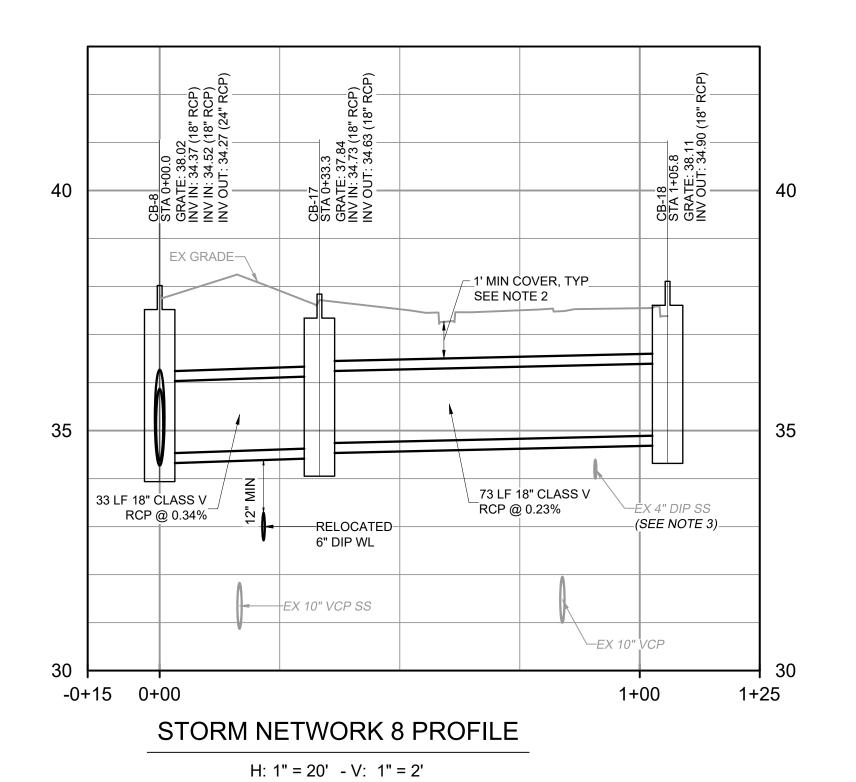


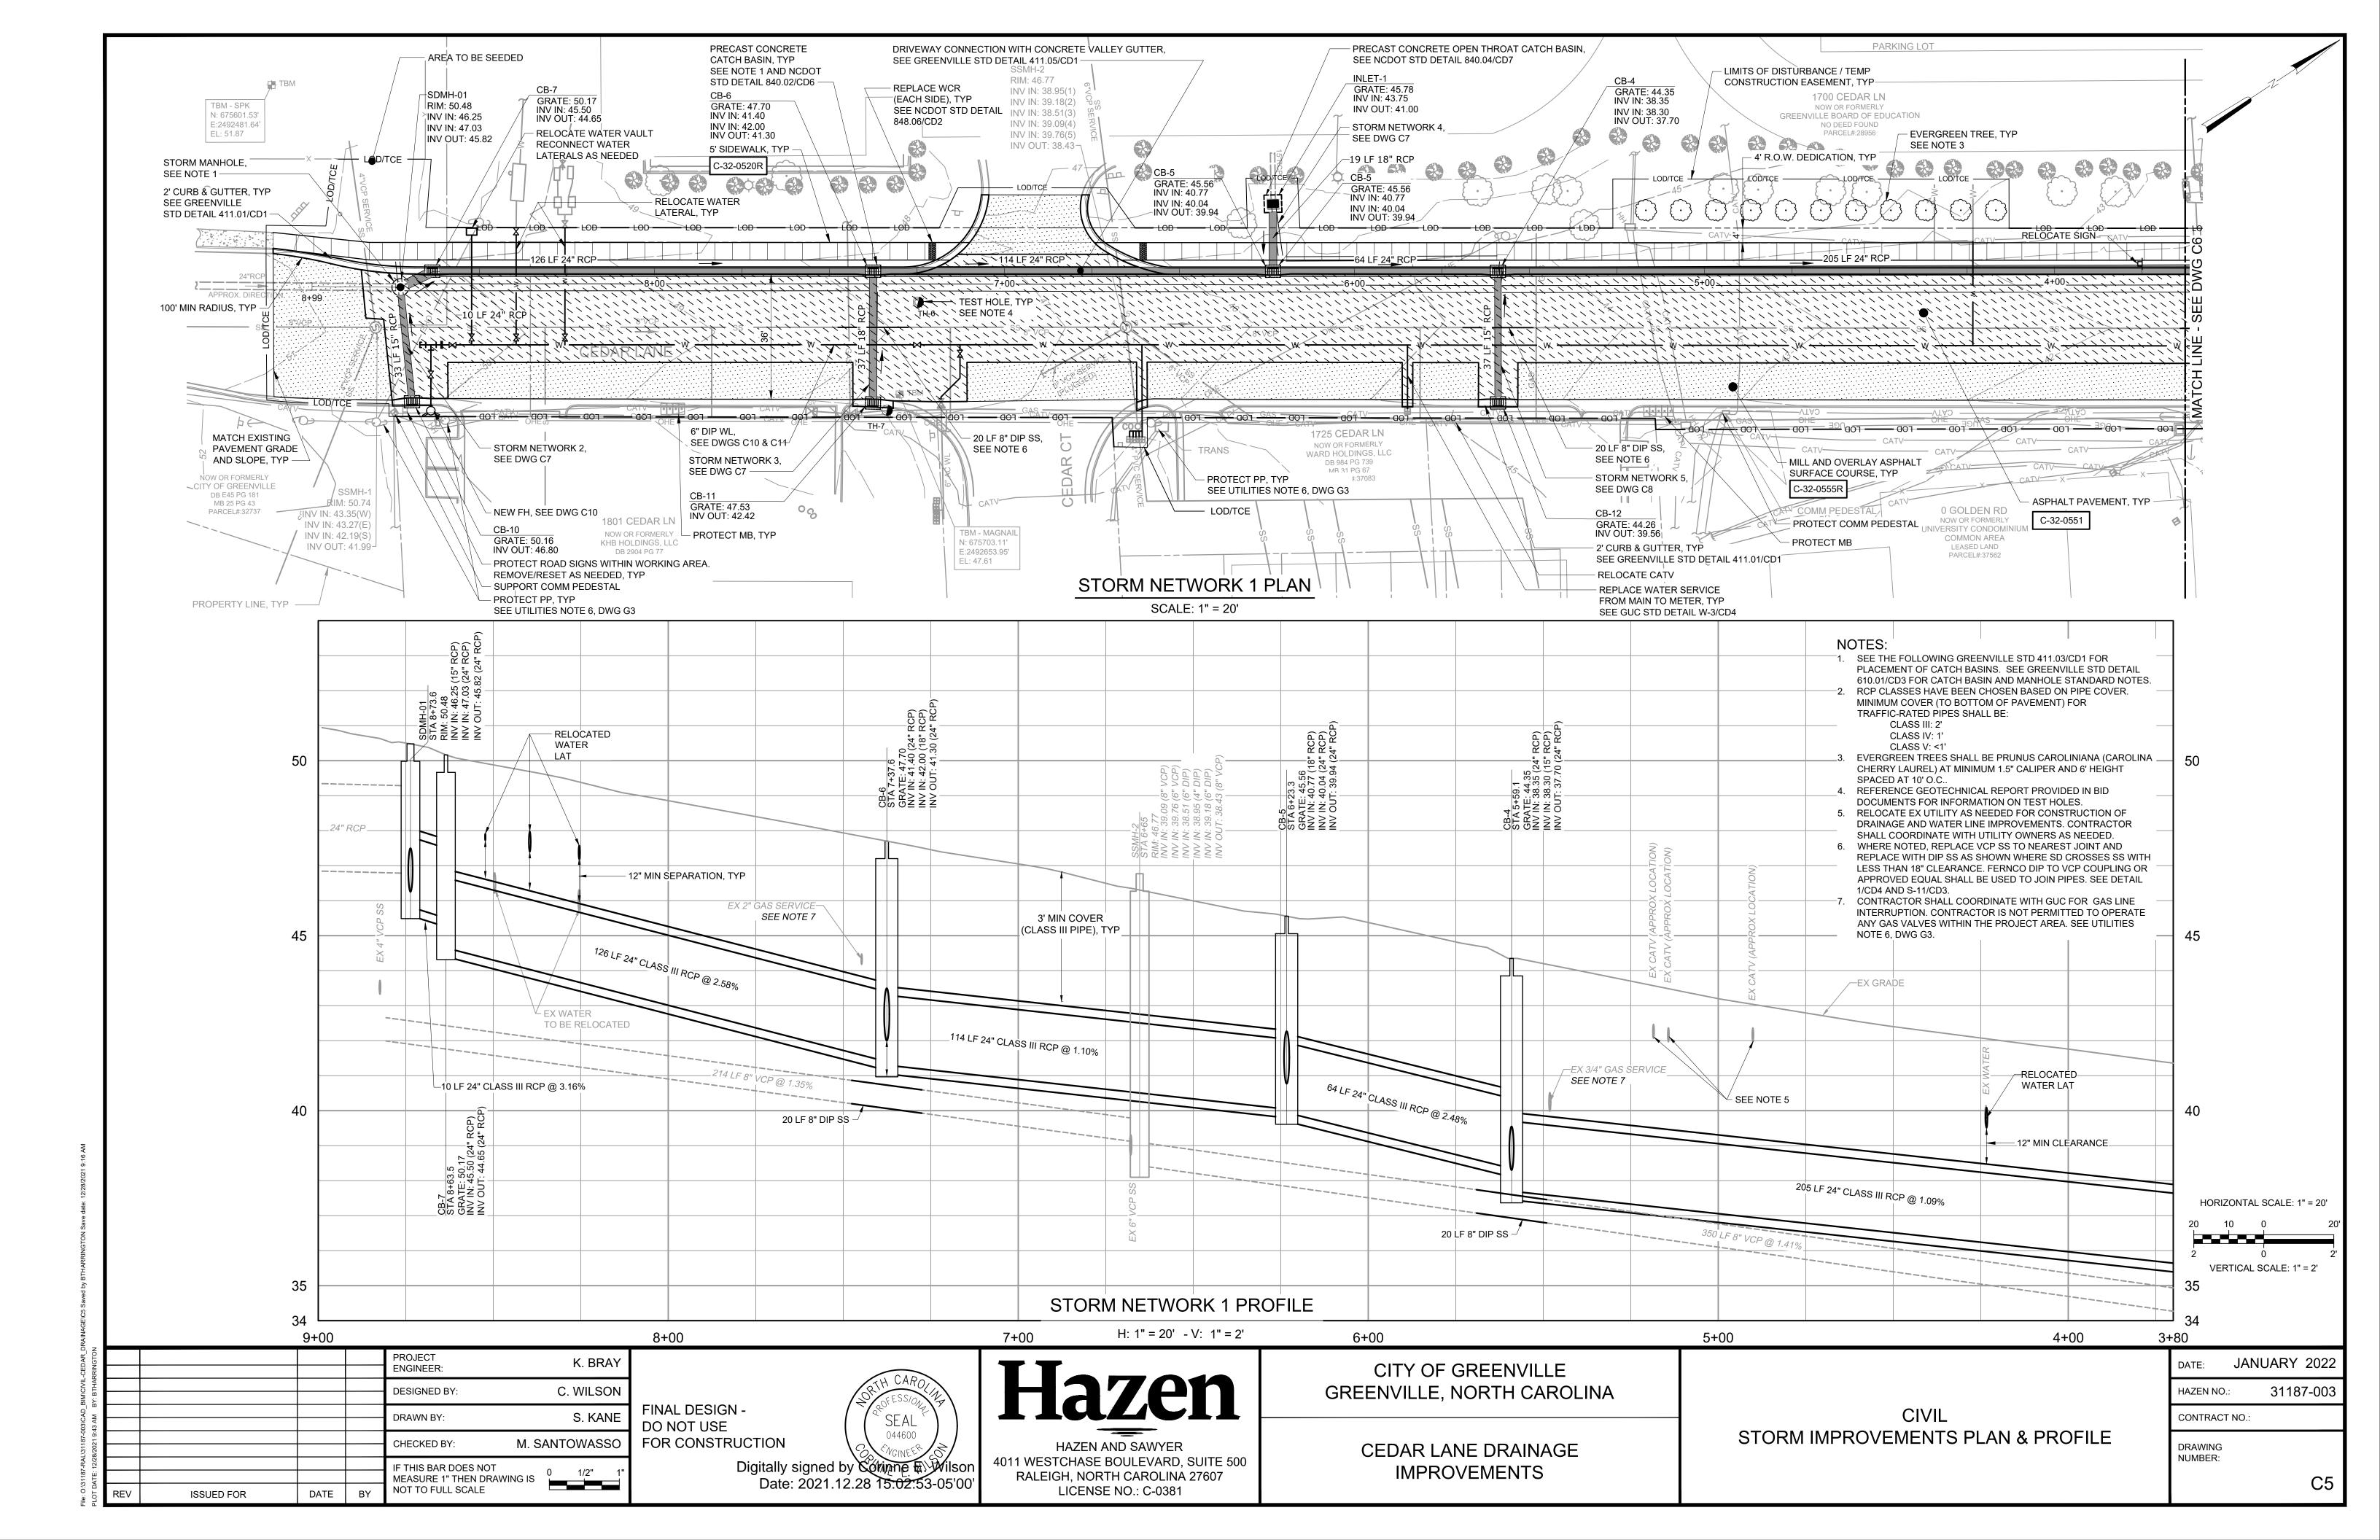


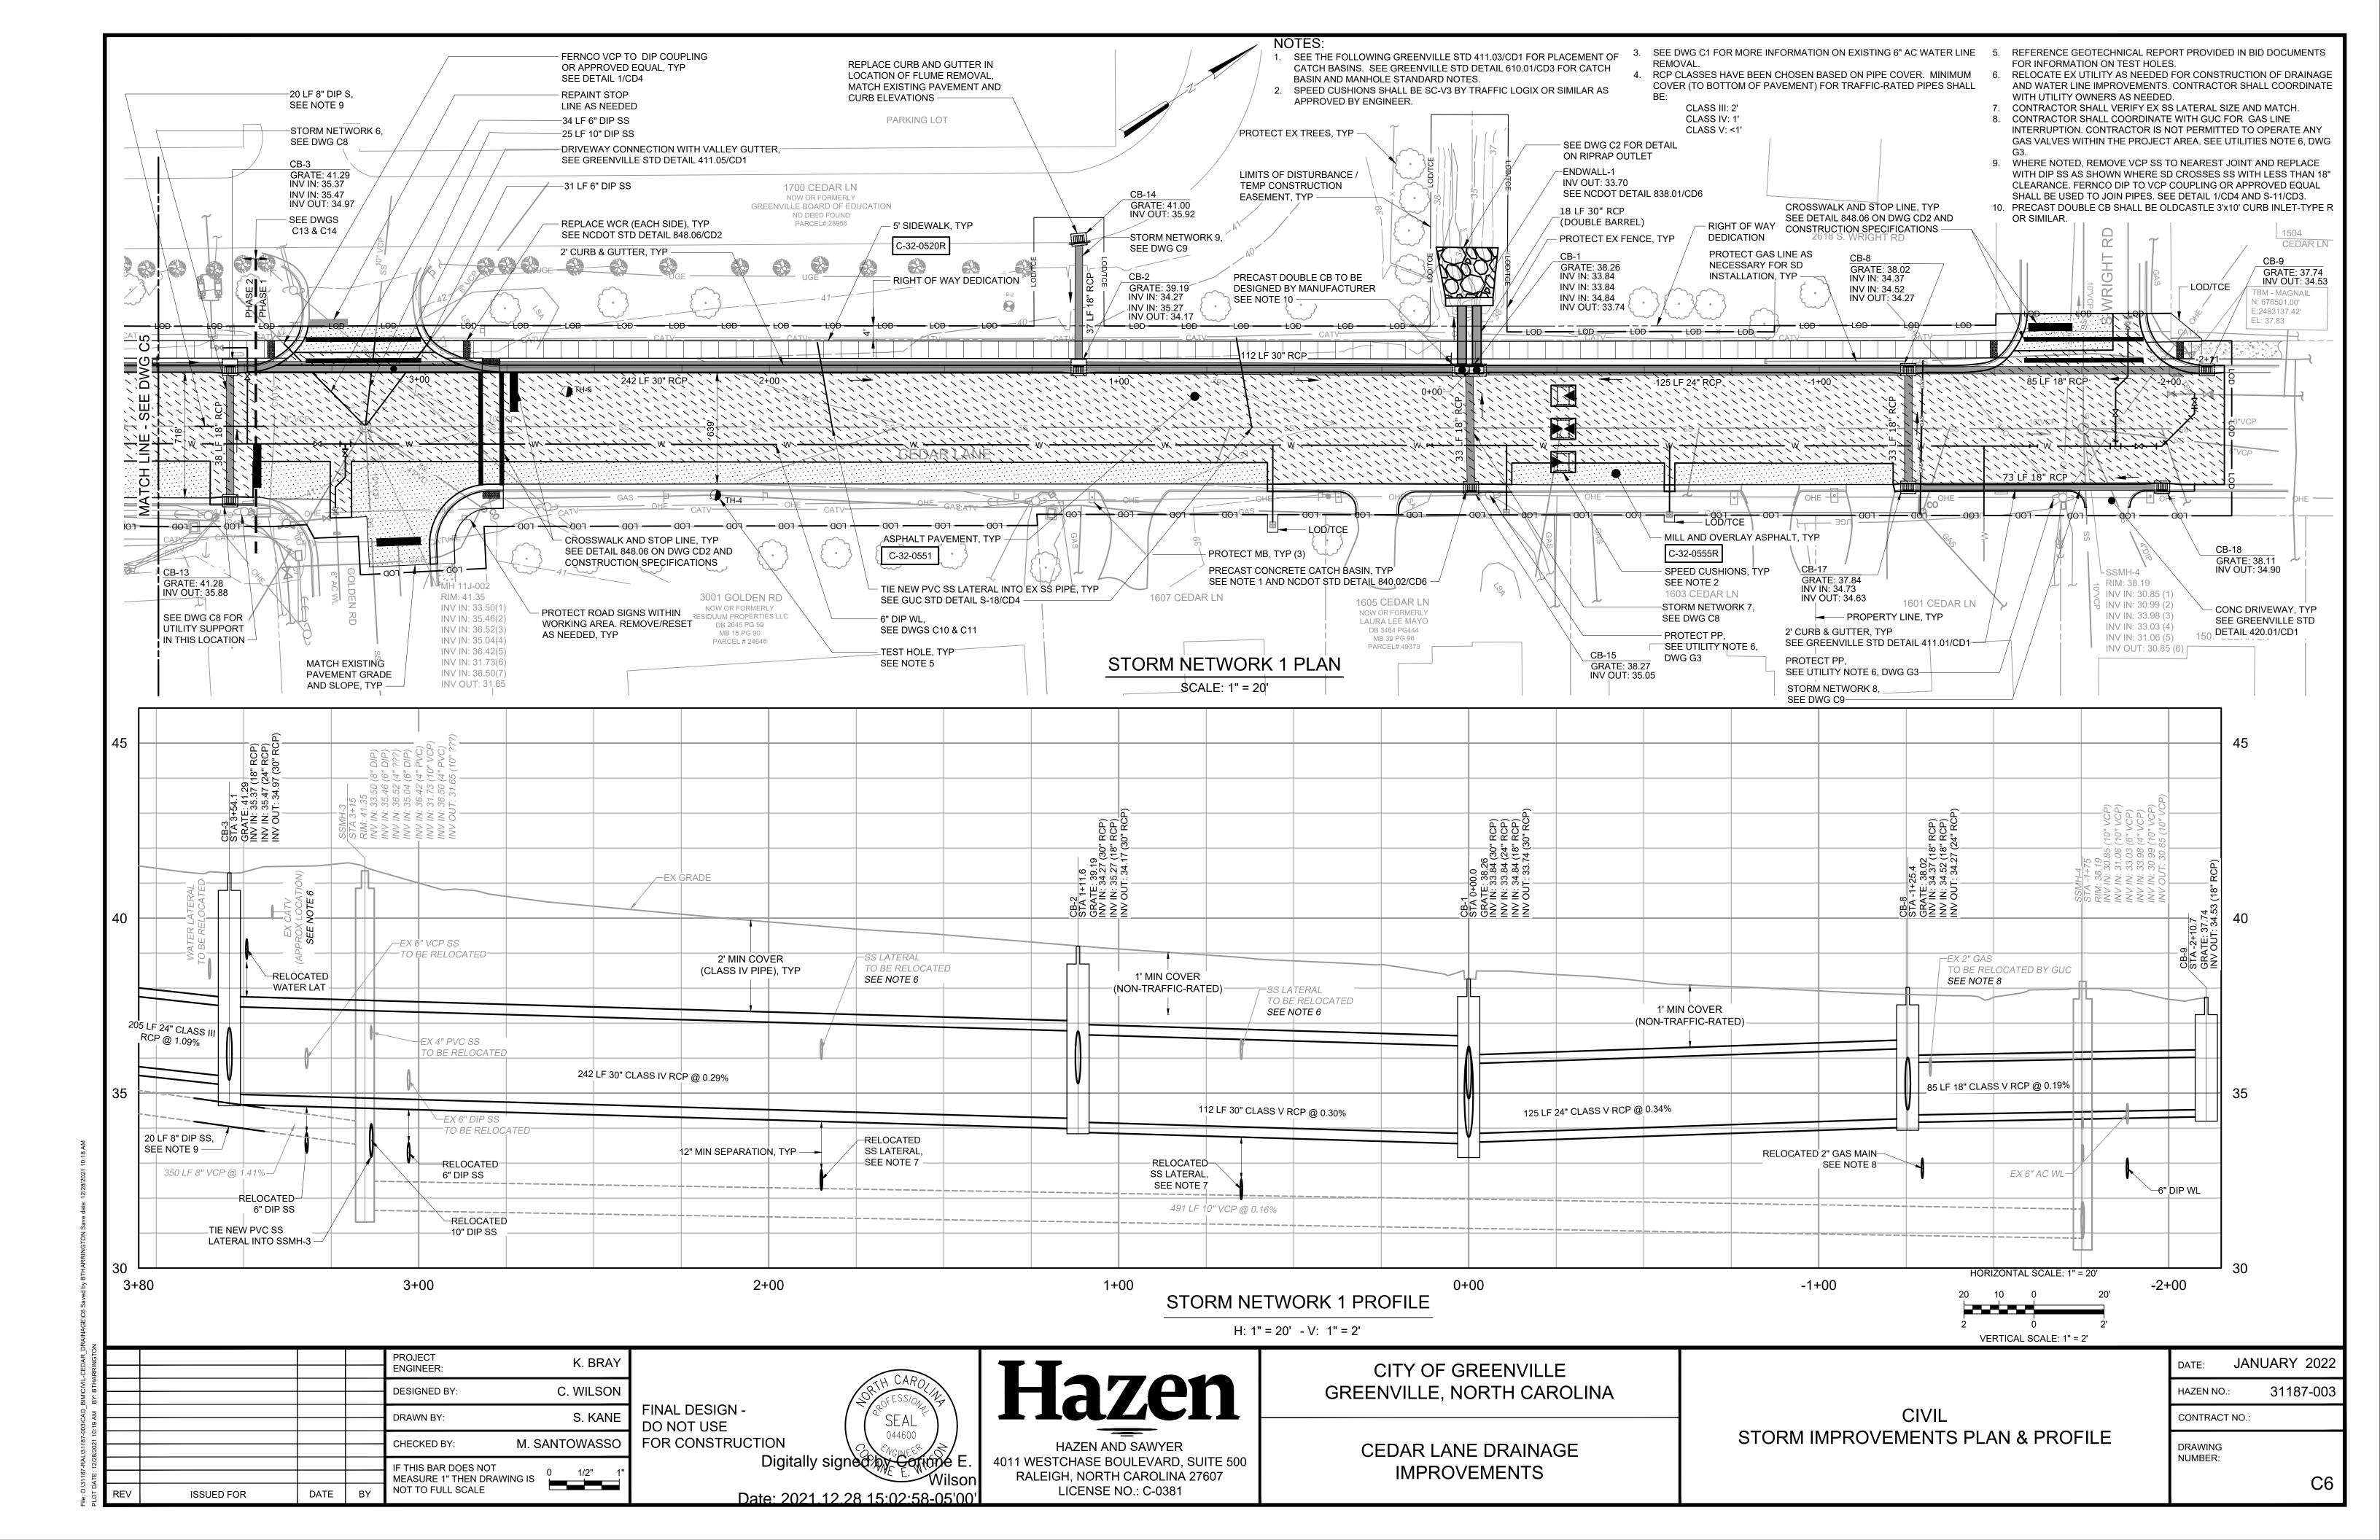


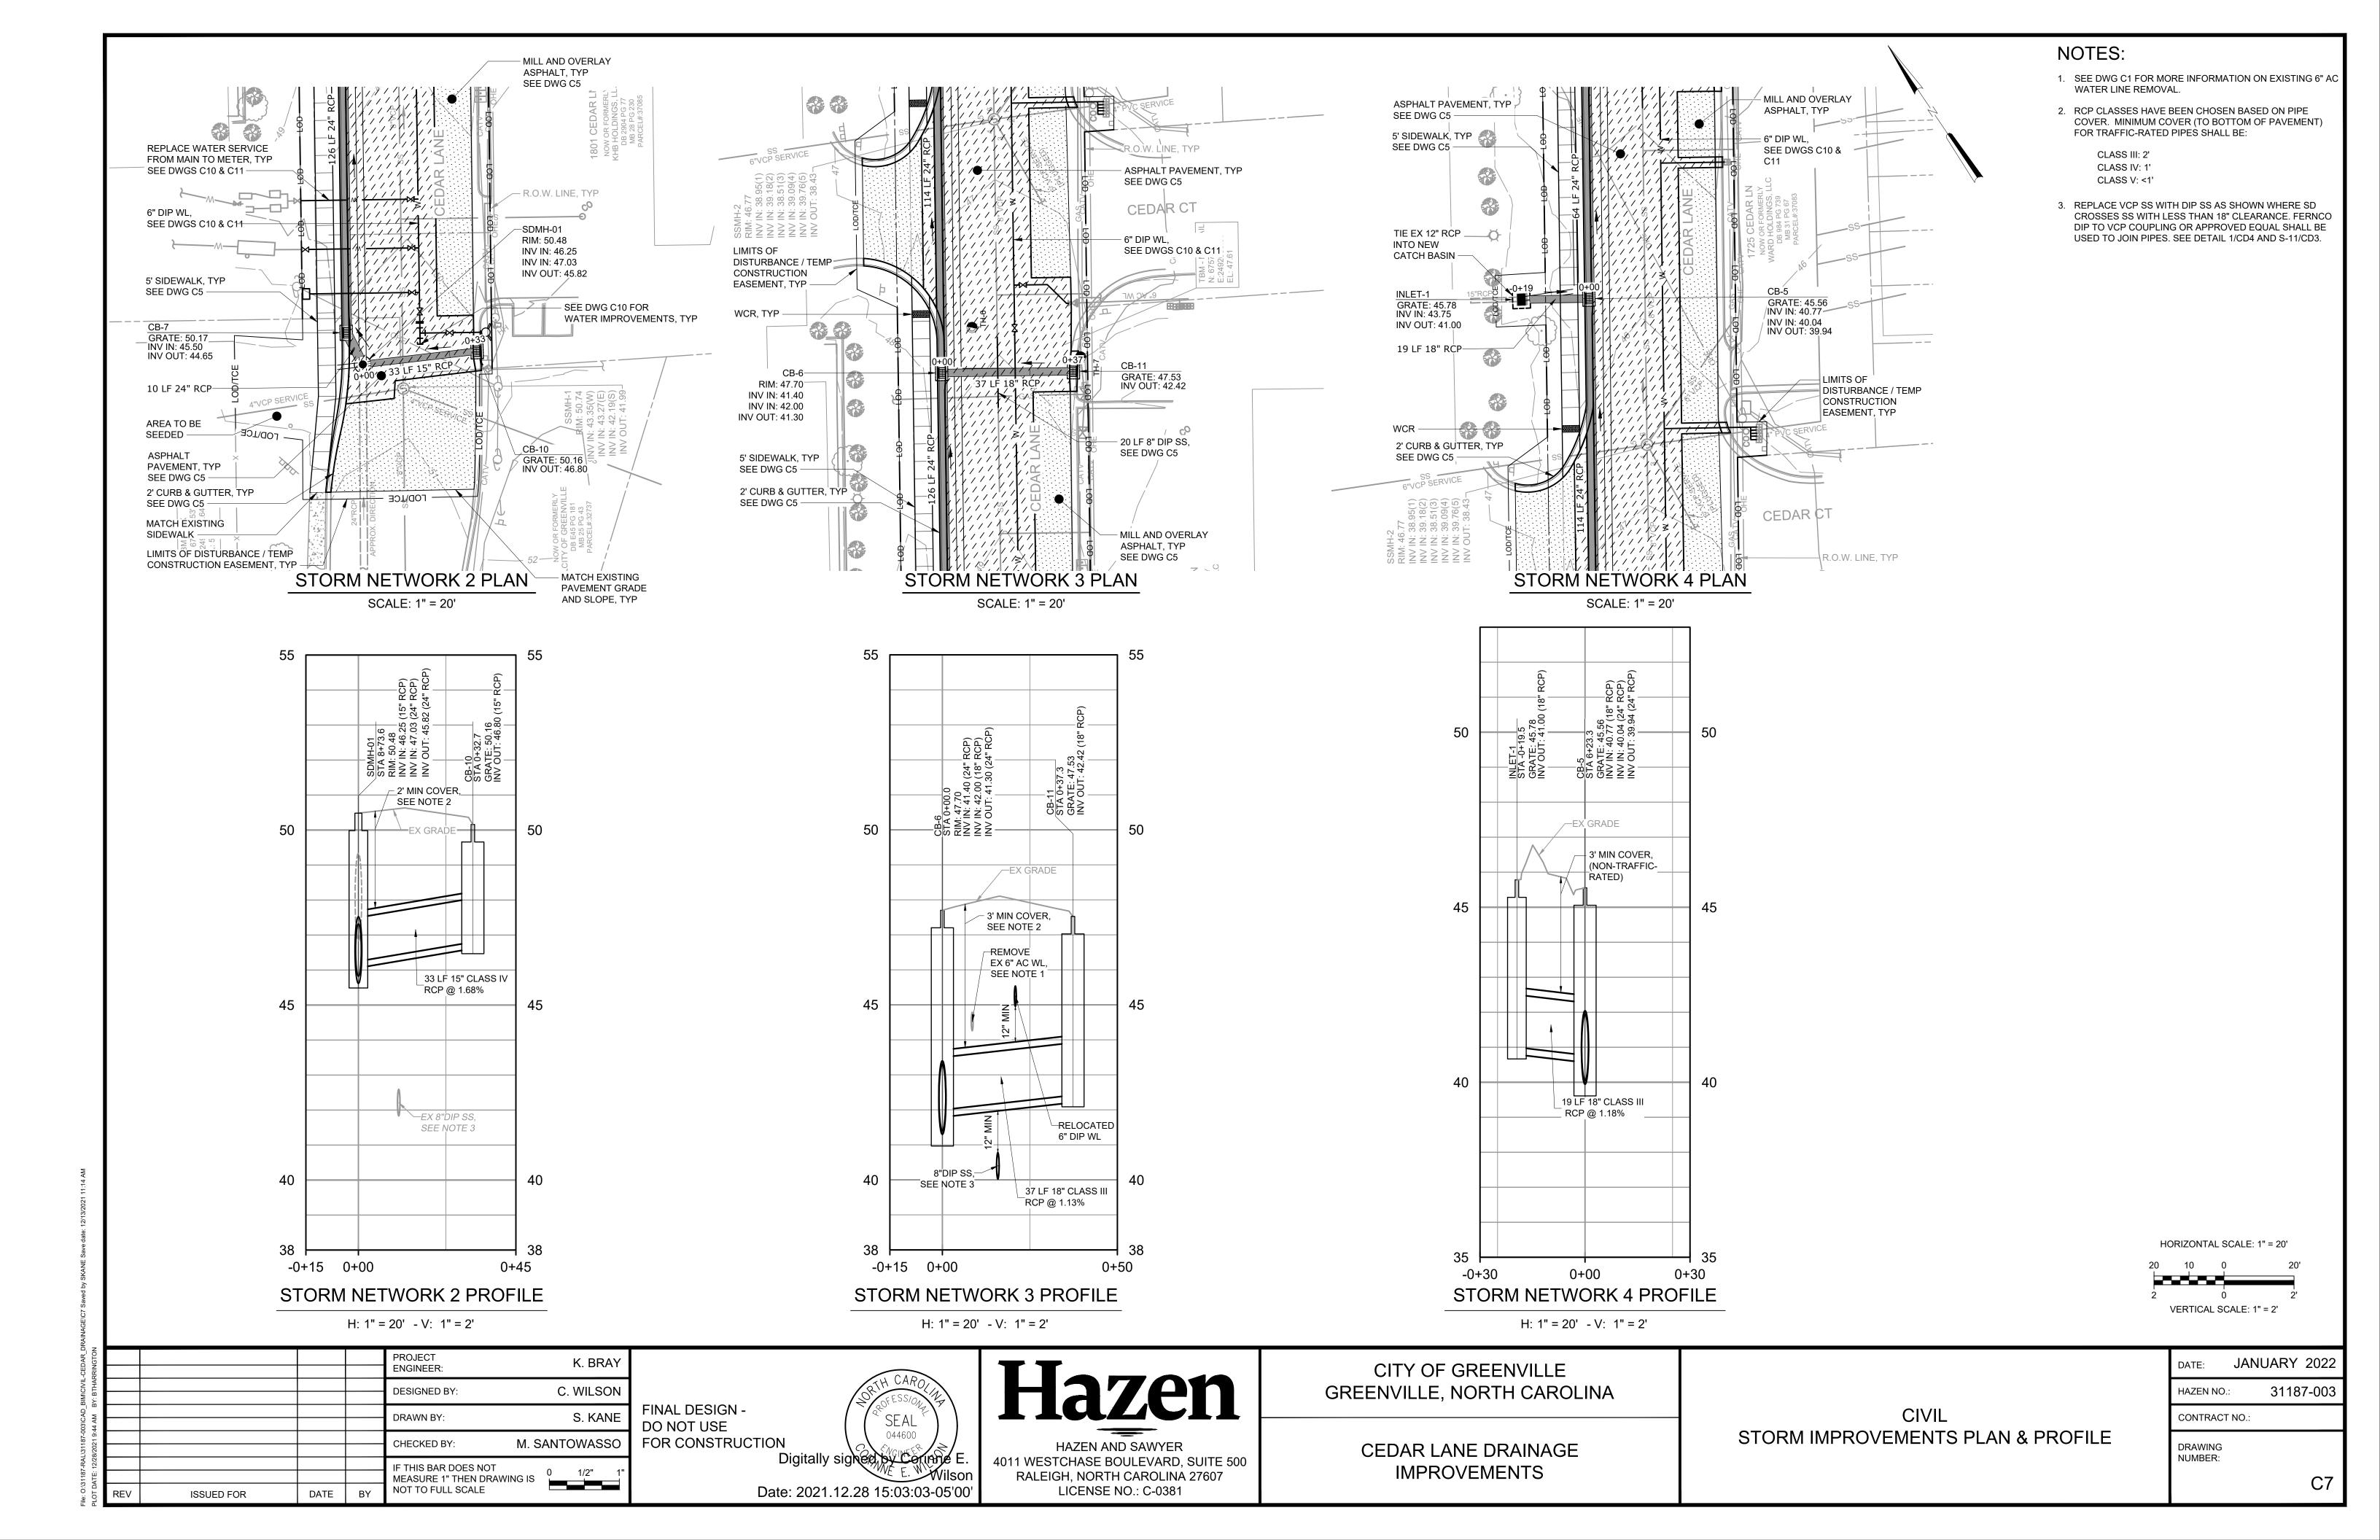

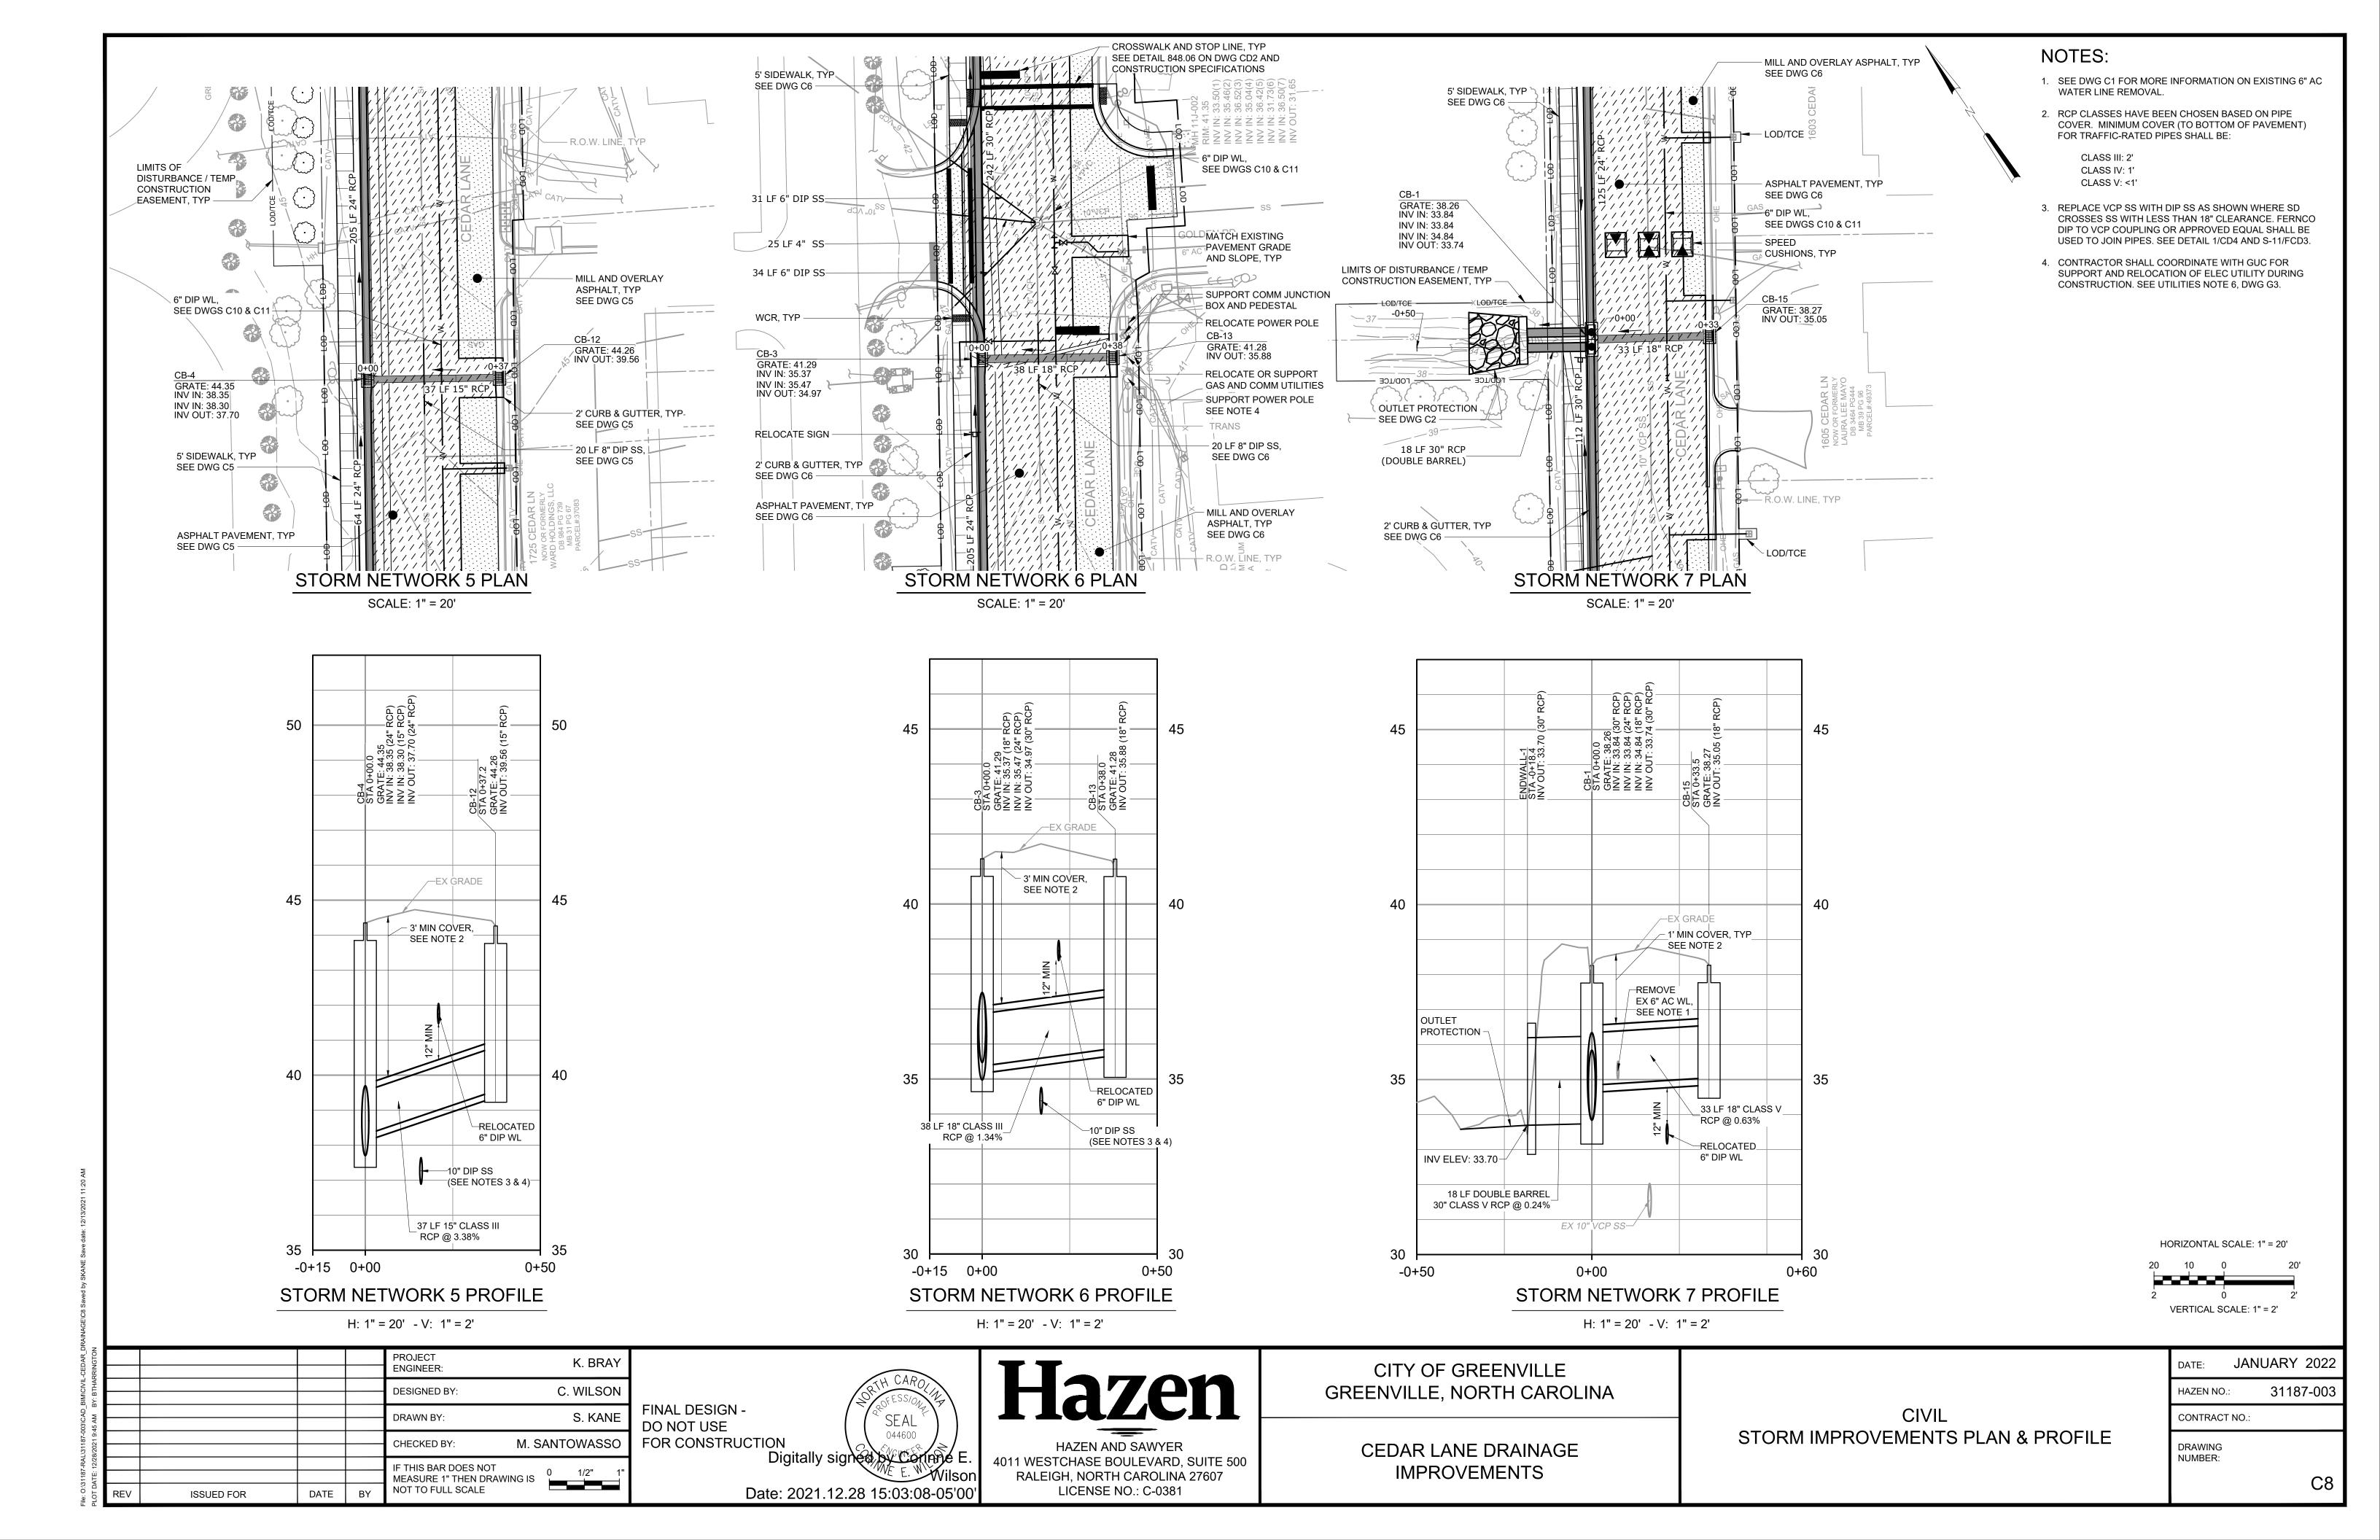

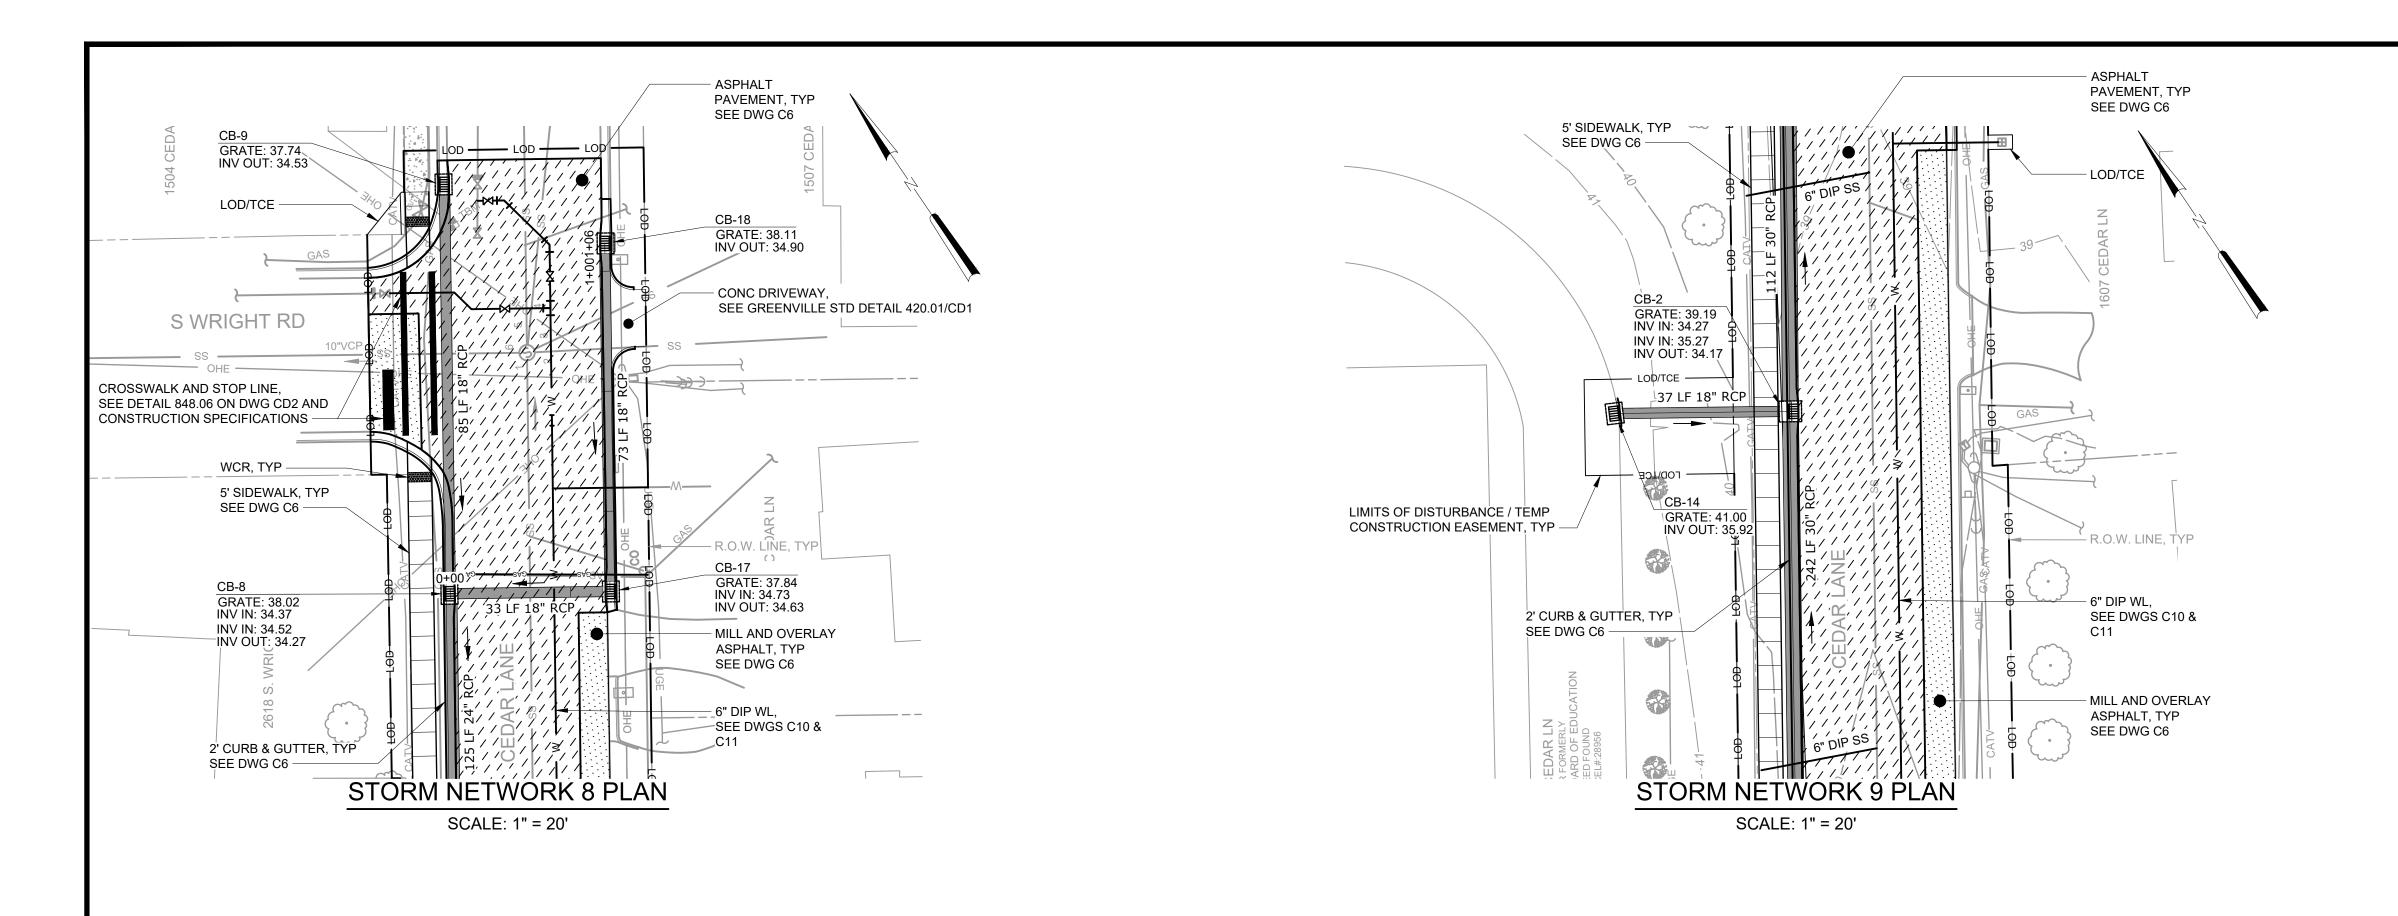

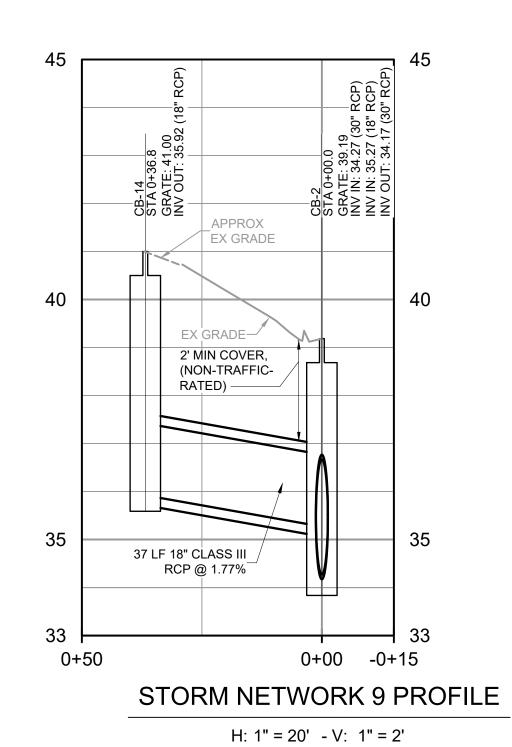

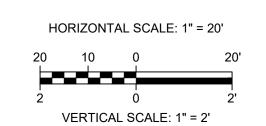

NOTES:

WATER LINE REMOVAL.

CLASS III: 2'

CLASS IV: 1' CLASS V: <1'

TRAFFIC-RATED PIPES SHALL BE:

1. SEE DWG C1 FOR MORE INFORMATION ON EXISTING 6" AC

COVER. MINIMUM COVER (TO BOTTOM OF PAVEMENT) FOR

2. RCP CLASSES HAVE BEEN CHOSEN BASED ON PIPE

3. REPLACE VCP SS WITH DIP SS AS SHOWN WHERE SD

CROSSES SS WITH LESS THAN 18" CLEARANCE. FERNCO

DIP TO VCP COUPLING OR APPROVED EQUAL SHALL BE USED TO JOIN PIPES. SEE DETAIL 1/CD4 AND S-11/CD3.

RAI						
iie: O:\31187-RAL\31187-003\CAD_BIM\CIVIL-CEDAR_DRAII 1LOT DATE: 12/28/2021 9:46 AM BY: BTHARRINGTON					PROJECT K. BRAY	
L-CE IRRI					ENGINEER.	4
MCIVI BTHA					DESIGNED BY: C. WILSON	
BY:						1.
CAD AM					DRAWN BY: S. KANE	ľ
7-003 9:46						┫┖
1187					CHECKED BY: M. SANTOWASSO	F
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FINAL DESIGN DO NOT USE
FOR CONSTRUCTION
Digitally signed by Coring E.
Wilson
Date: 2021.12.28 15:03:13-05'00'

HAZEN AND SAWYER
4011 WESTCHASE BOULEVARD, SUITE 500
RALEIGH, NORTH CAROLINA 27607


LICENSE NO.: C-0381


# CITY OF GREENVILLE GREENVILLE, NORTH CAROLINA


CEDAR LANE DRAINAGE IMPROVEMENTS


CIVIL
STORM IMPROVEMENTS PLAN & PROFILE

DATE:	JANUARY 2022
HAZEN NO.:	31187-003
CONTRACT	NO.:
DRAWING NUMBER:	
	C9

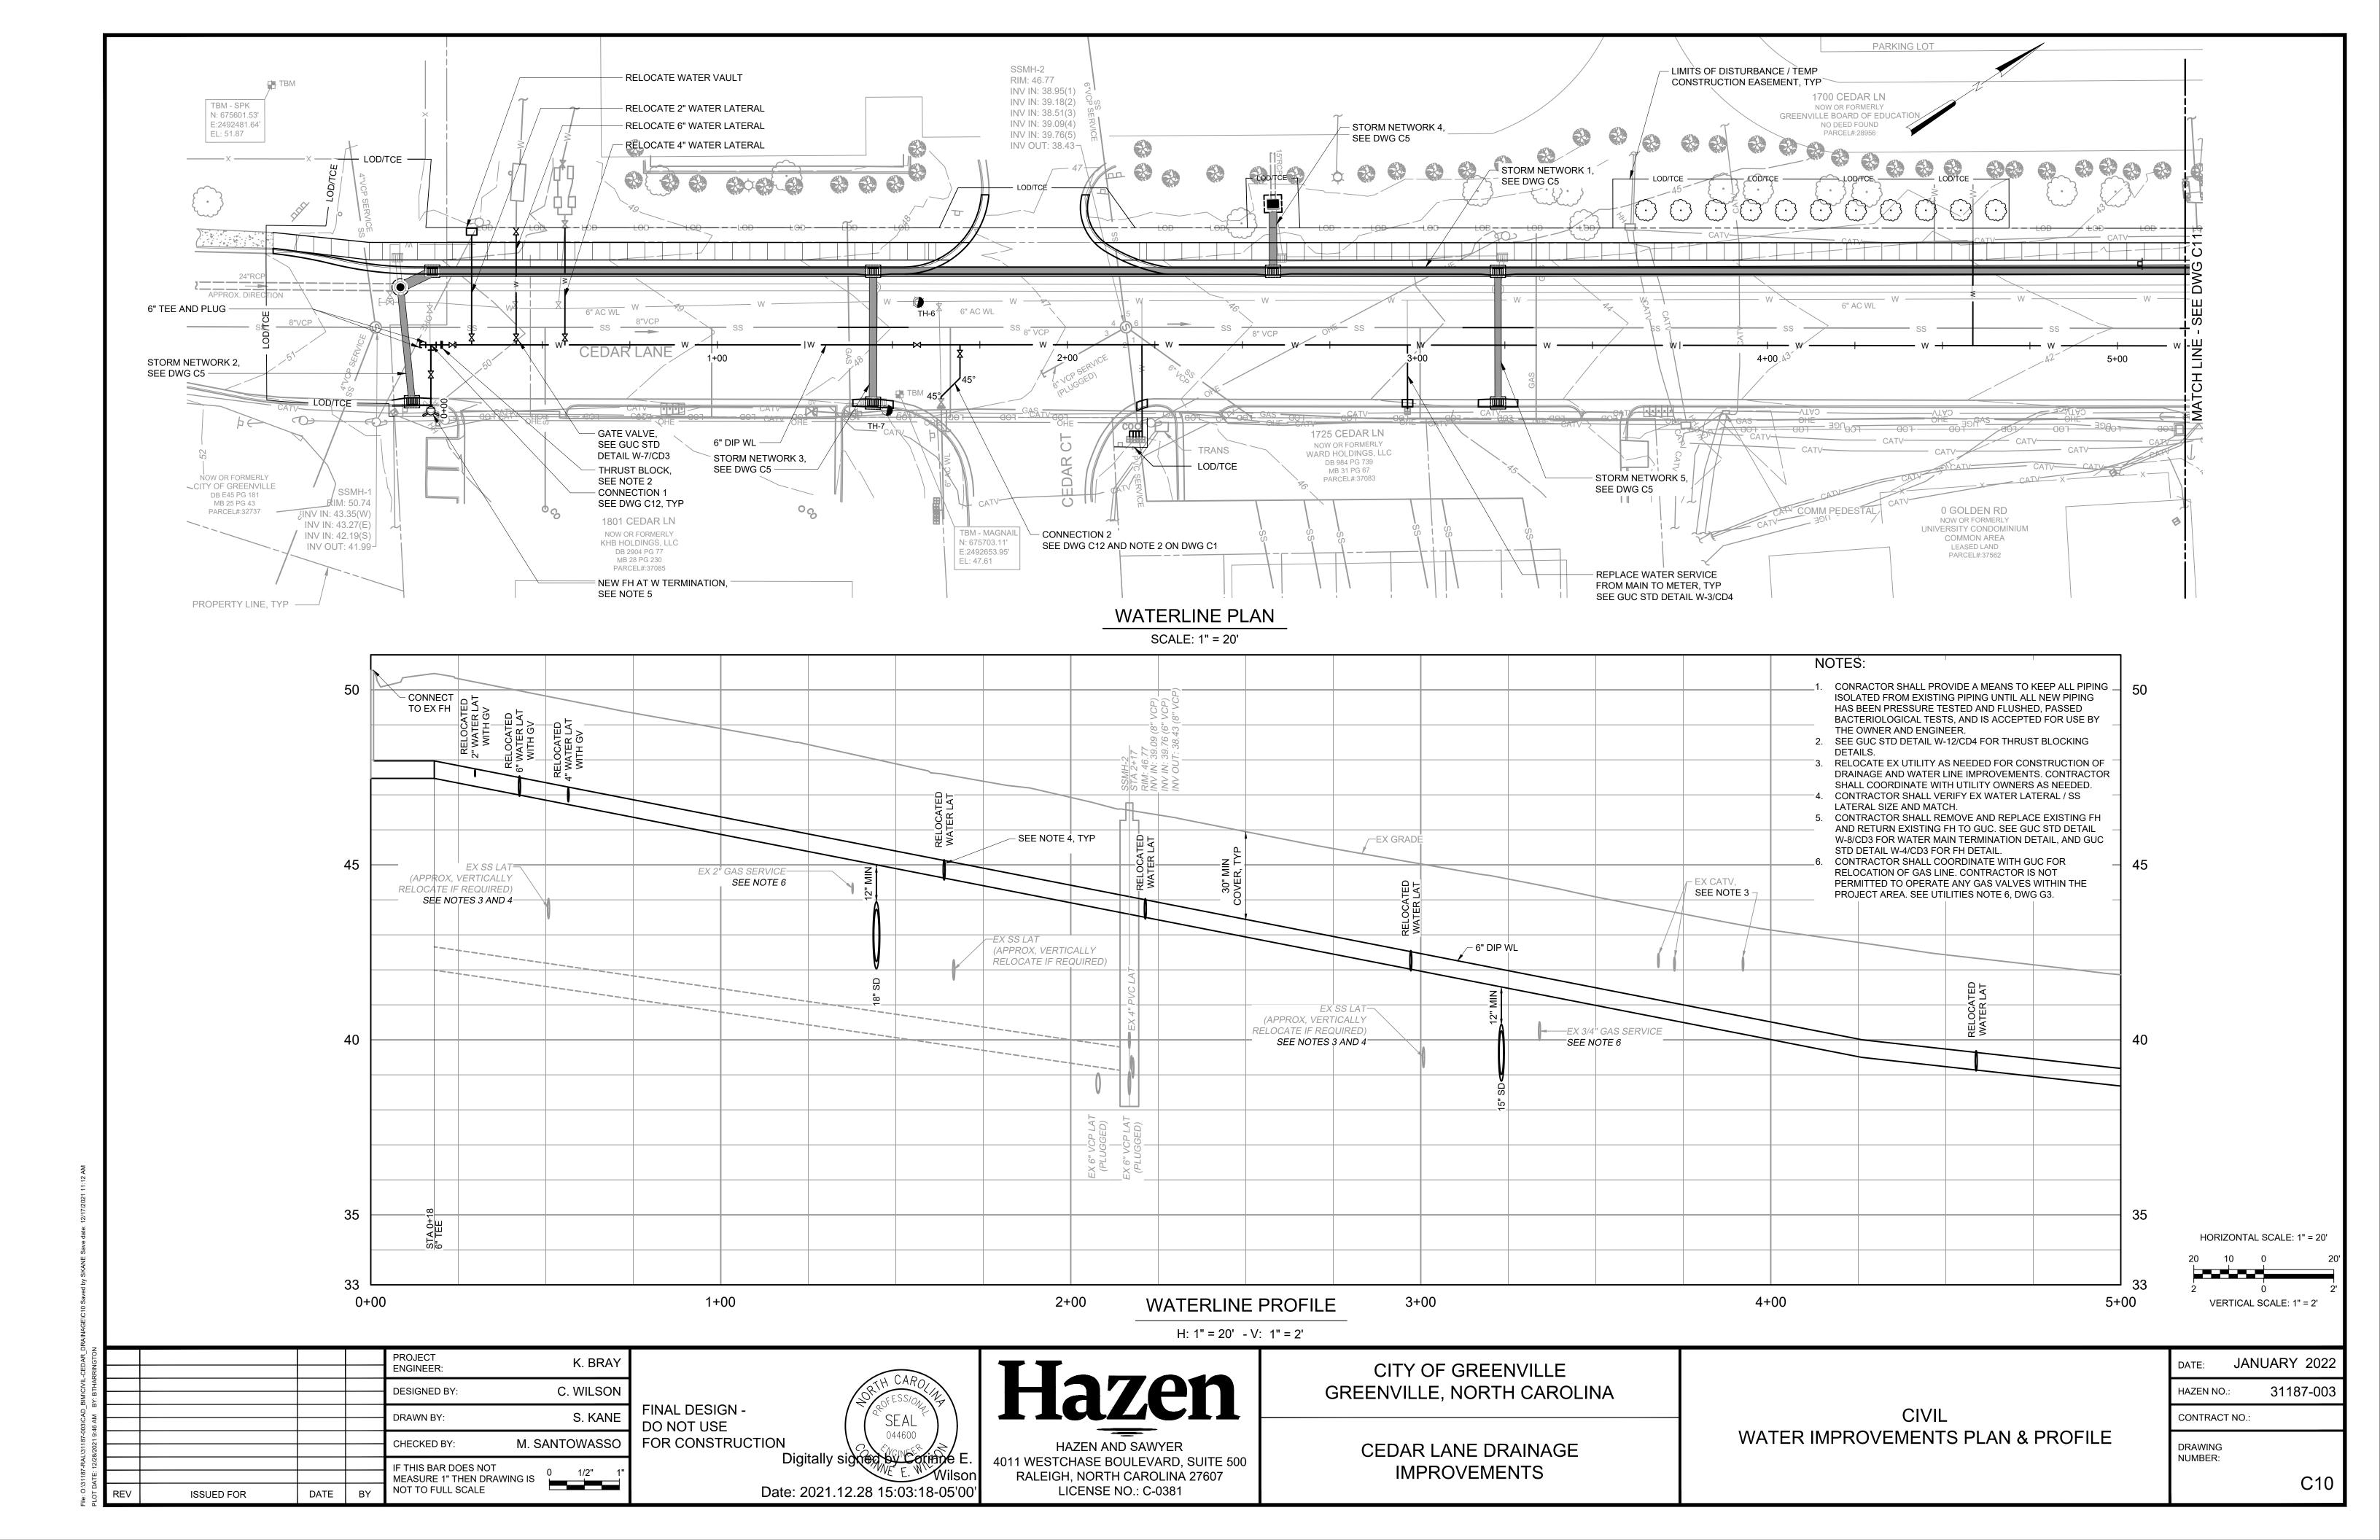


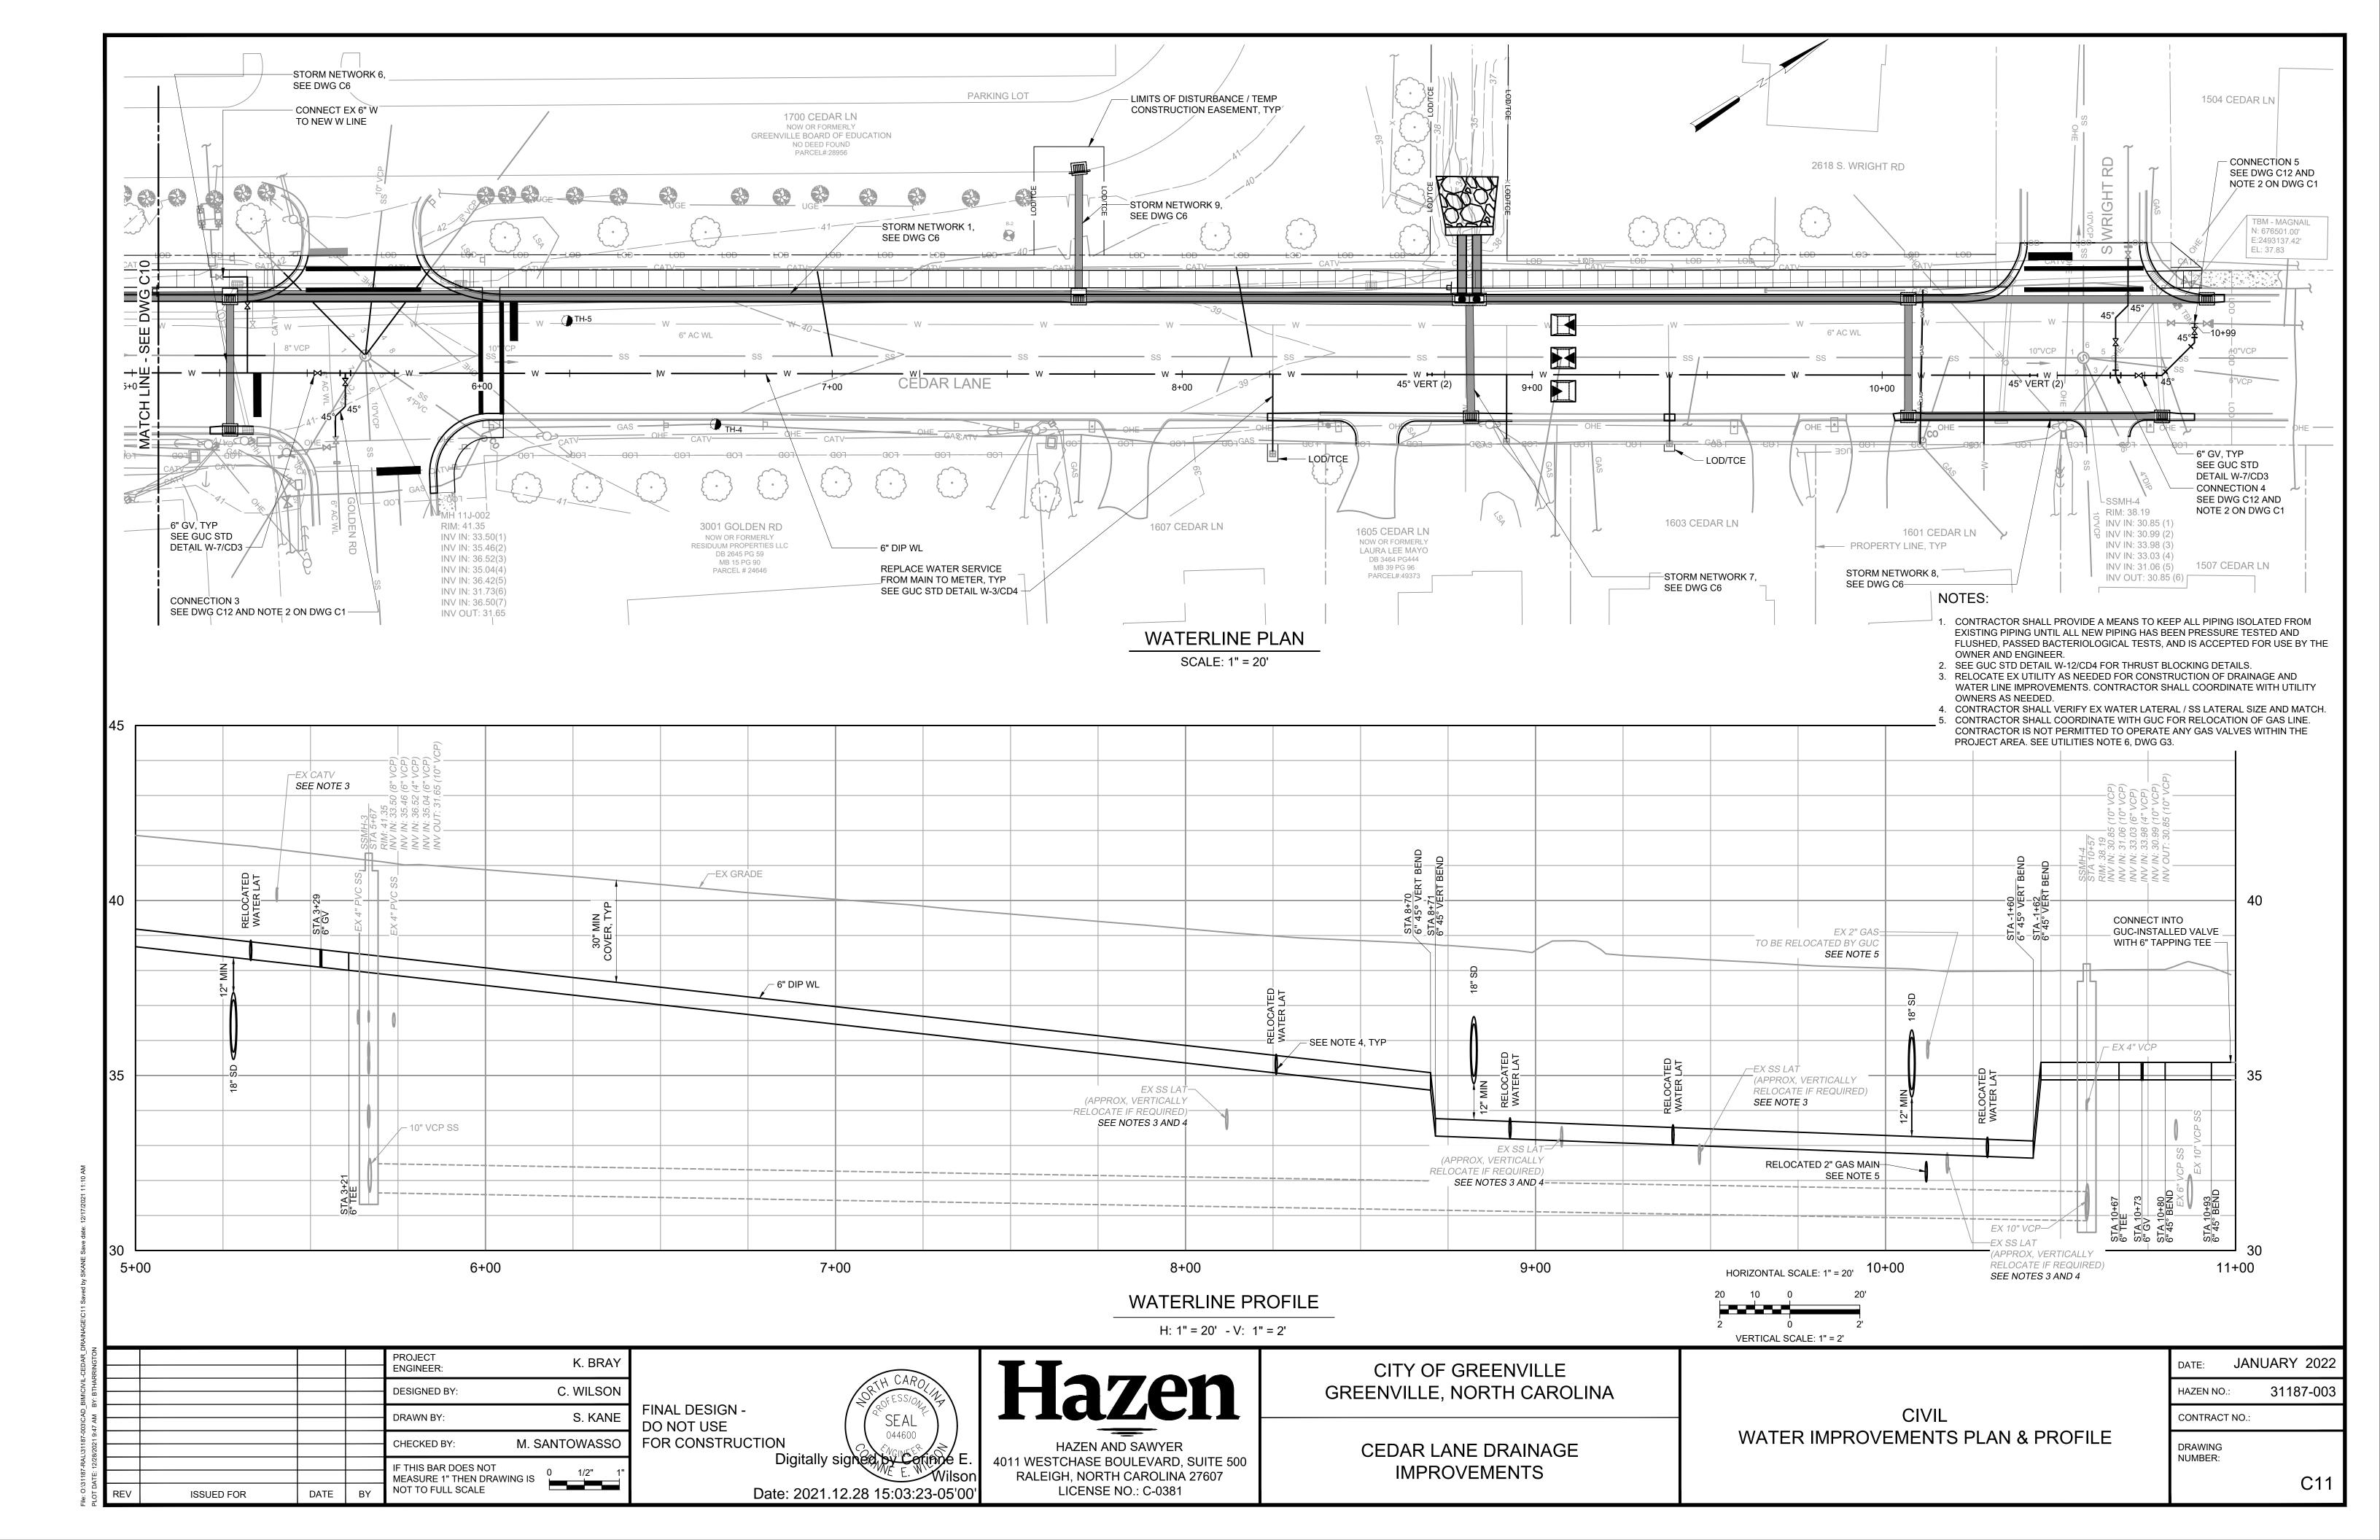

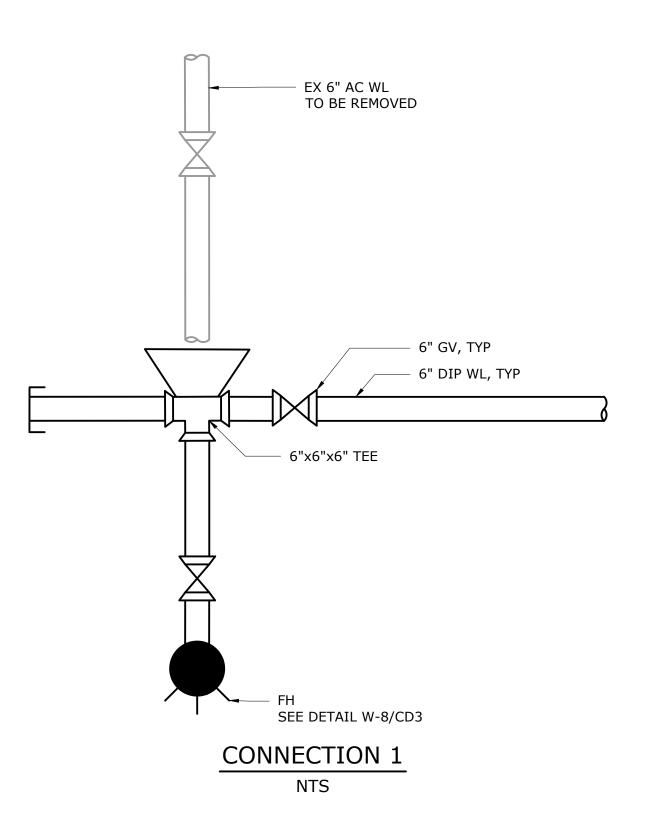

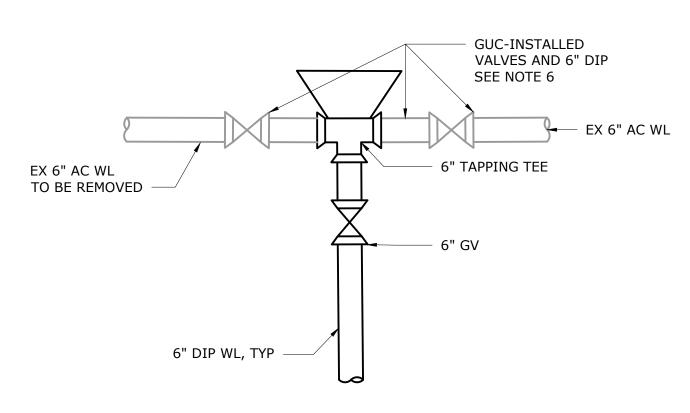

CONNECTION 5

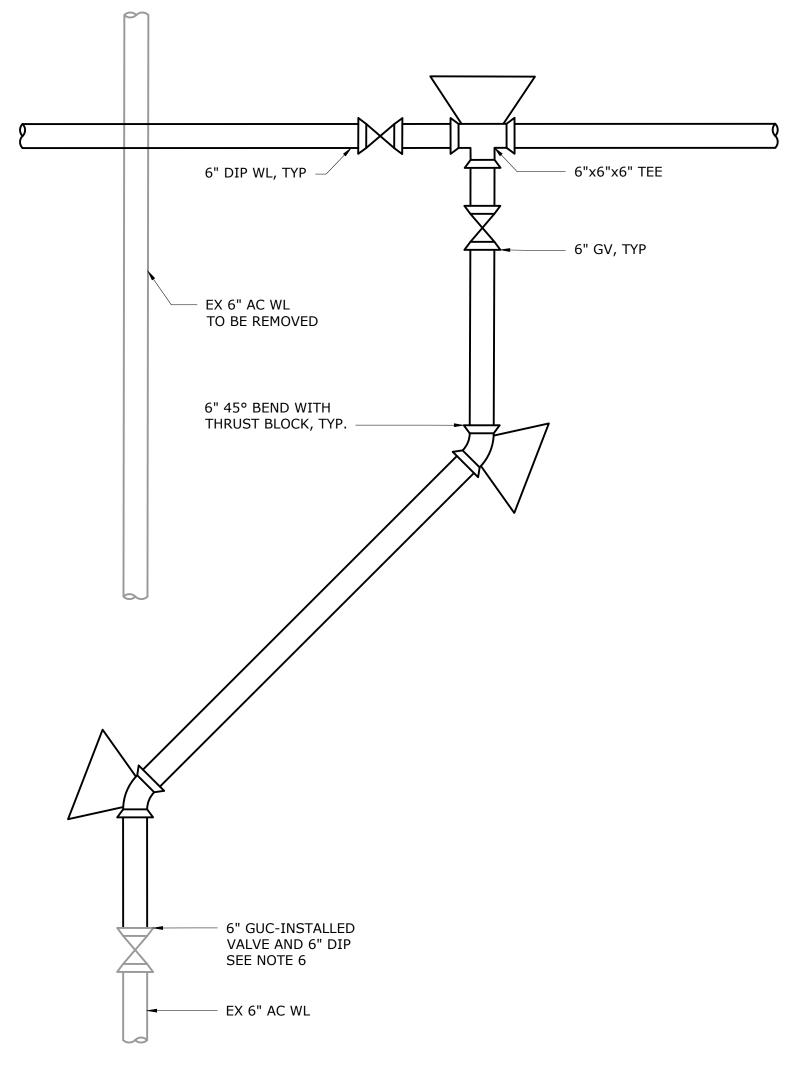

CONNECTION 2, 3, 4

PROJECT
ENGINEER:

DESIGNED BY:

C. WILSON

DRAWN BY:

S. KANE

CHECKED BY:


M. SANTOWASSO

IF THIS BAR DOES NOT
MEASURE 1" THEN DRAWING IS
NOT TO FULL SCALE

ISSUED FOR

FINAL DESIGN DO NOT USE
FOR CONSTRUCTION

Digitally signed by Corinnell Wilson
Date: 2021.12.28 15.03:30-05'00'

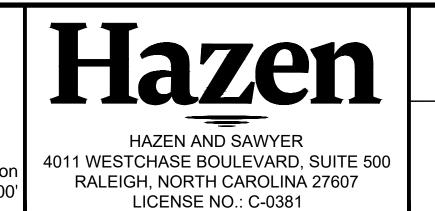

CITY OF GREENVILLE GREENVILLE, NORTH CAROLINA

CEDAR LANE DRAINAGE IMPROVEMENTS

CIVIL WATER CONNECTION DETAILS

NOTES:

1. FITTINGS SHALL BE MJ DI WITH MEGALUG, OR

2. EXISTING WATER LINES ARE ASBESTOS CEMENT.

SEWER THE BOTTOM OF THE WATER LINE SHALL

BE A MINIMUM OF 18" ABOVE THE TOP OF THE

4. PROPERLY DISPOSE OF ANY EXISTING WATER LINE

5. ALL SERVICES SHALL BE RECONNECTED TO THE

NEW WATER LINE PRIOR TO REMOVAL OF THE

6. FOR CONNECTIONS TO GUC-INSTALLED VALVES, CONTRACTOR SHALL CONNECT TO DIP WITH A

RESTRAINED MECHANICAL JOINT COUPLING ON THE DOWNSTREAM SIDE OF THE NEW VALVE

3. WHERE THE WATER LINE CROSSES OVER THE

EQUAL, RESTRAINING GLANDS.


TO BE REMOVED.


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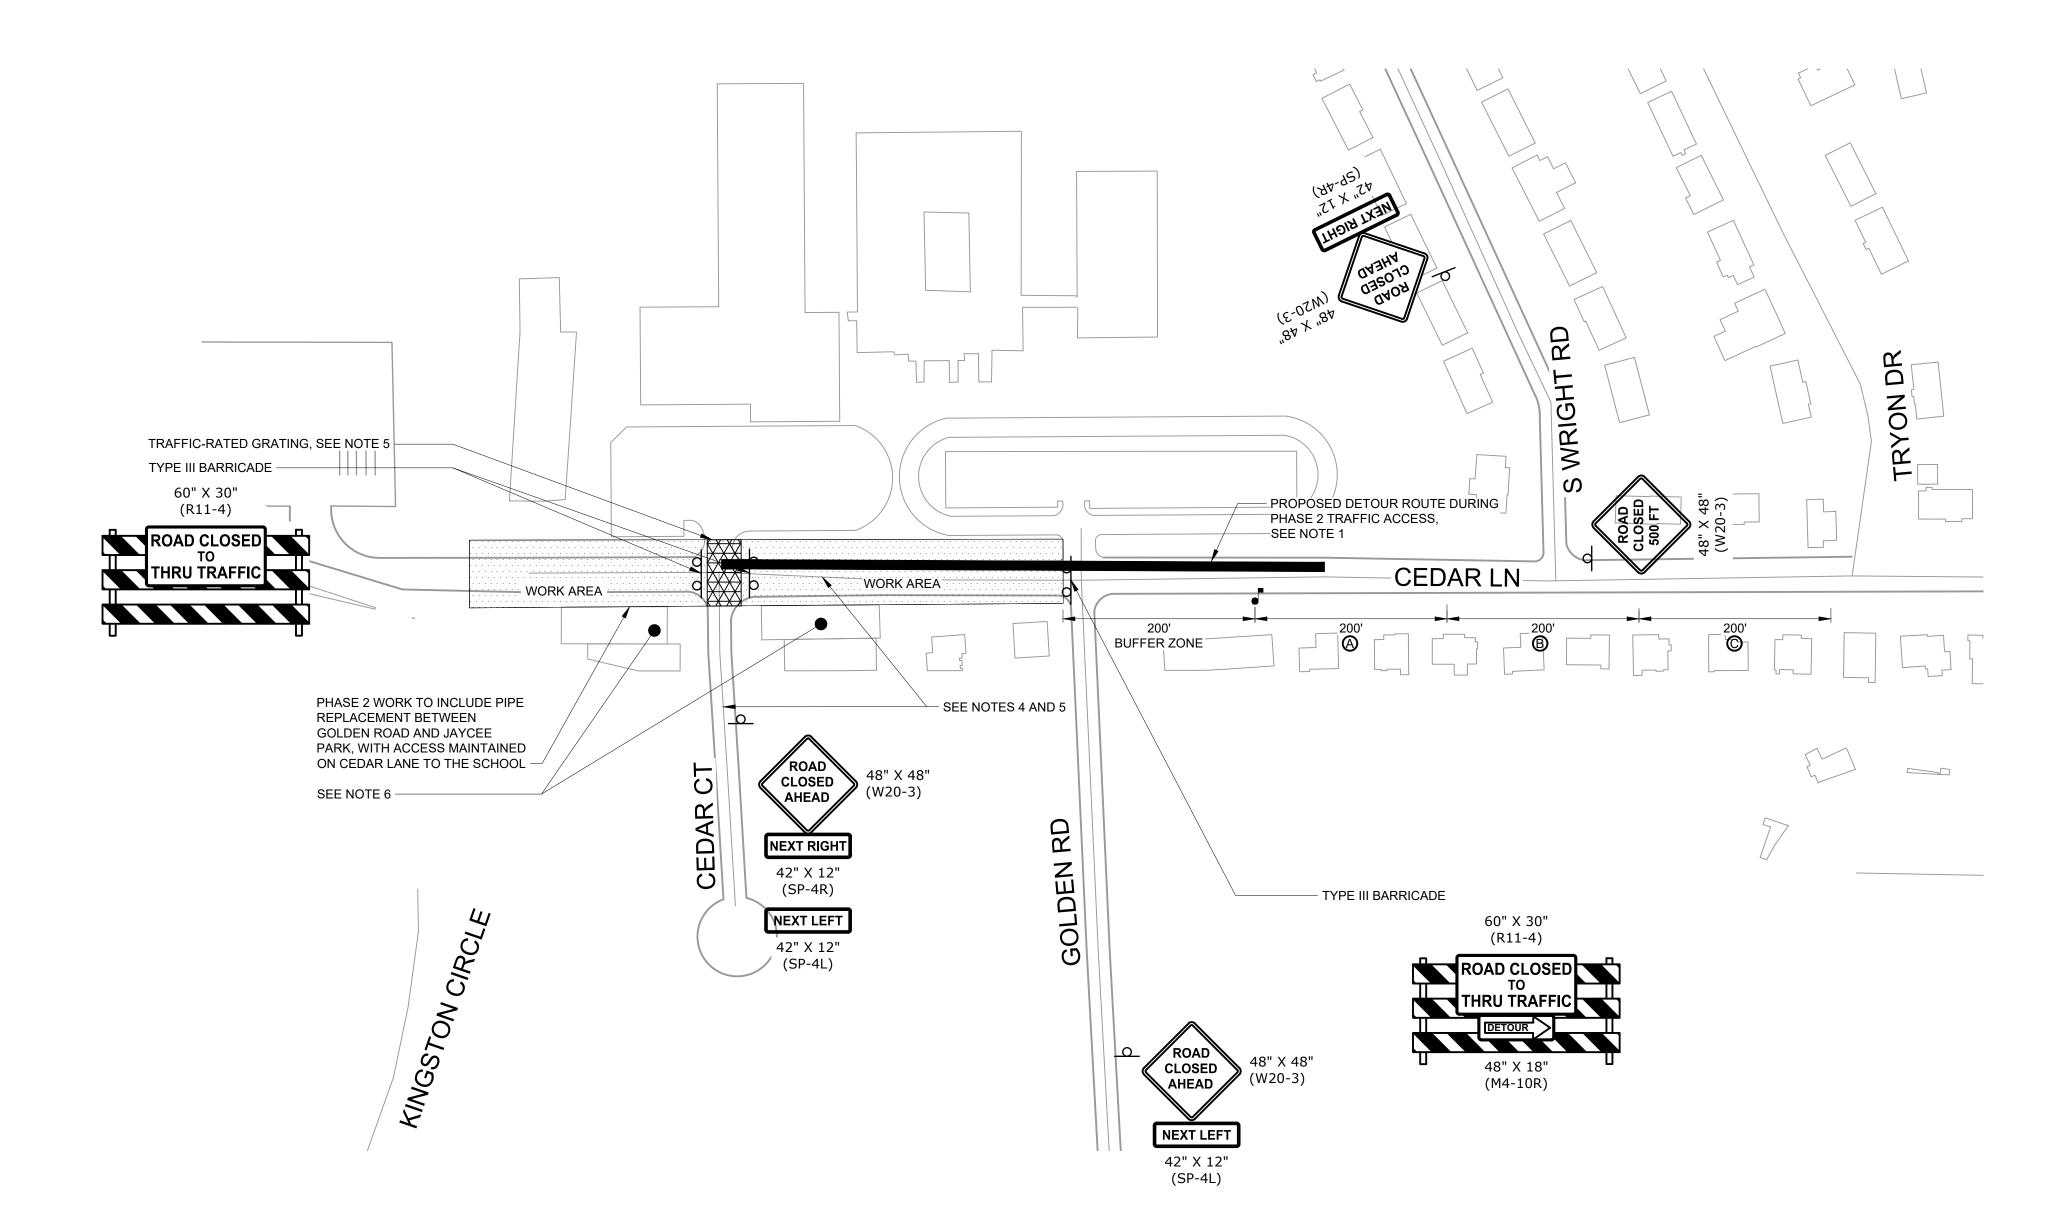
INSTALLED BY GUC.

DATE:	JANUARY 2022
HAZEN NO.:	31187-003
CONTRACT	NO.:
DRAWING NUMBER:	

C12



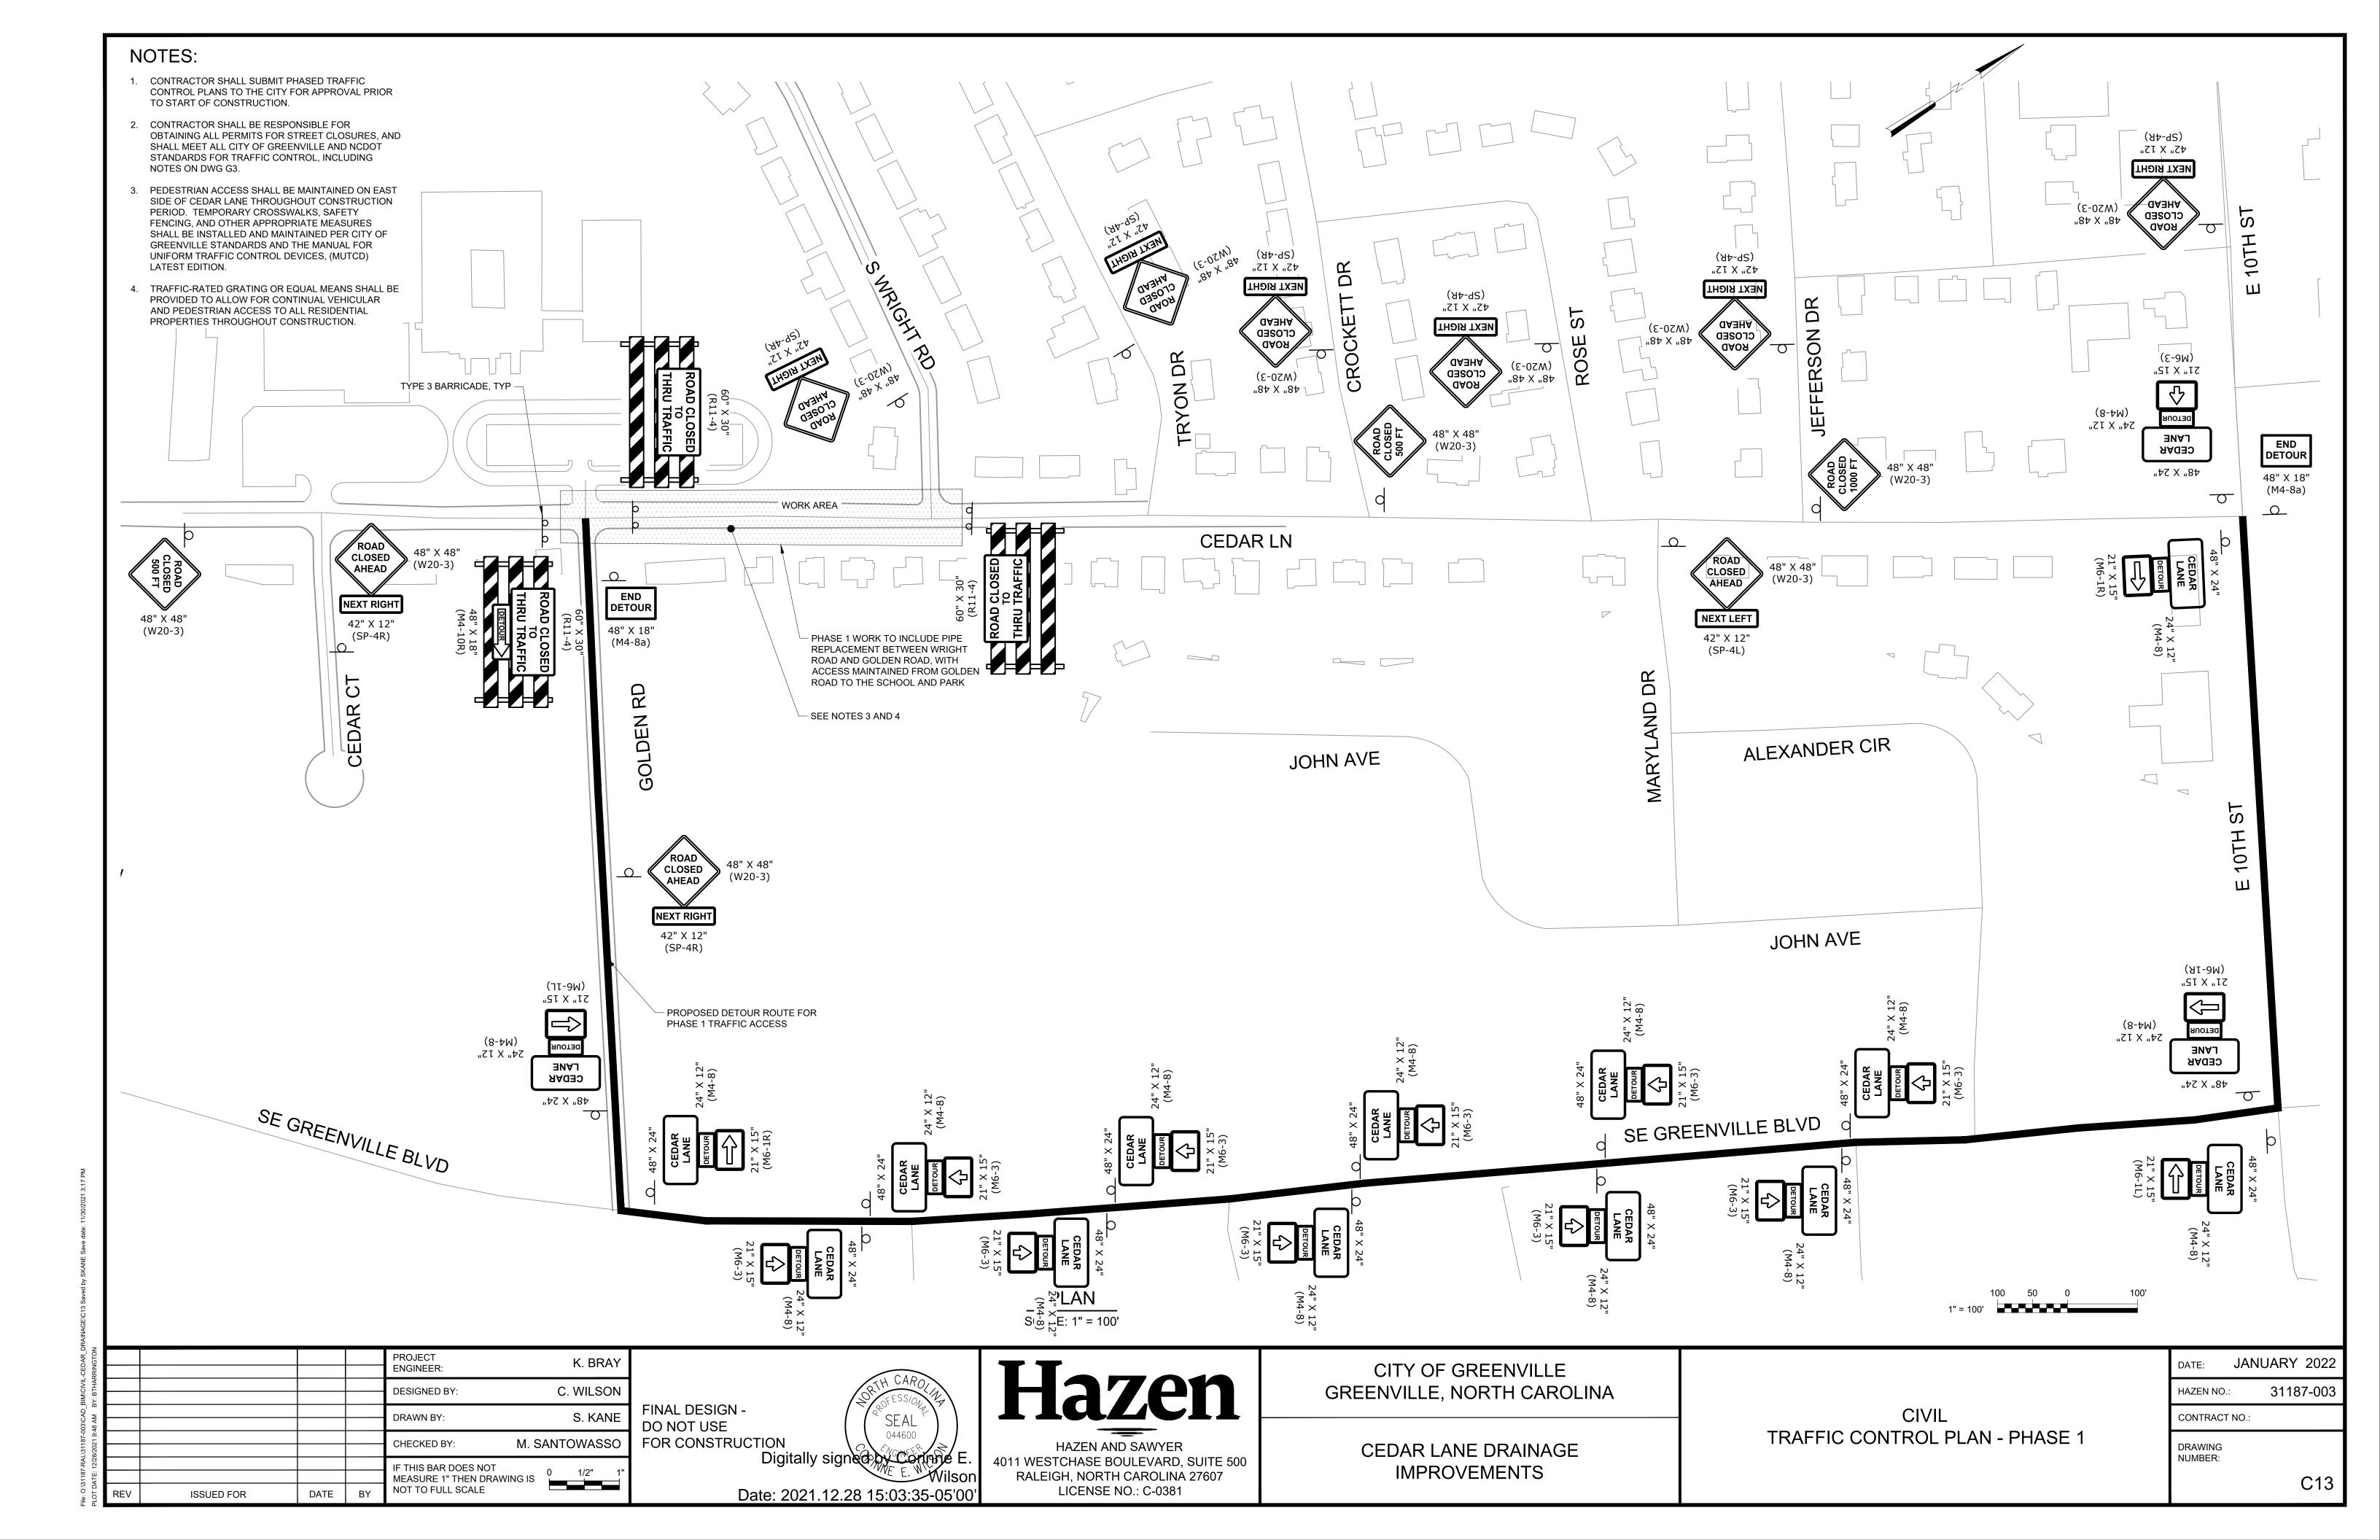

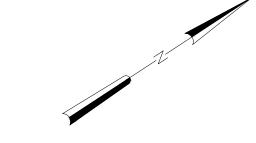

## NOTES:

- 1. CONSTRUCTION SHALL BE PHASED TO ALLOW FOR ACCESS TO THE SCHOOL GROUNDS DURING SCHOOL HOURS. WORK IN THIS PHASE SHALL BE COMPLETED WHILE MAINTAINING ONE-WAY TRAFFIC DURING THE DAY WHILE CONSTRUCTION TASKS PROGRESS. FLAGMAN CONTROL IN WORK ZONE SHALL BE PROVIDED FOR ONE DIRECTIONAL TRAFFIC. NO AUTOMATIC FLAGGING IS ALLOWABLE. ROAD SHALL BE OPENED TO BI-DIRECTIONAL TRAFFIC AT THE CLOSE OF EACH WORK DAY. SEE NCDOT DETAIL 1150.01 ON DWG CD9 FOR FLAGGER REQUIREMENTS.
- 2. CONTRACTOR SHALL SUBMIT PHASED TRAFFIC CONTROL PLANS TO THE CITY FOR APPROVAL PRIOR TO START OF CONSTRUCTION.
- 3. CONTRACTOR SHALL BE RESPONSIBLE FOR OBTAINING ALL PERMITS FOR STREET CLOSURES, AND SHALL MEET ALL CITY OF GREENVILLE AND NCDOT STANDARDS FOR TRAFFIC CONTROL, INCLUDING NOTES ON DWG G3.
- 4. PEDESTRIAN ACCESS SHALL BE MAINTAINED ON EAST SIDE OF CEDAR LANE THROUGHOUT CONSTRUCTION PERIOD. TEMPORARY CROSSWALKS, SAFETY FENCING, AND OTHER APPROPRIATE MEASURES SHALL BE INSTALLED AND MAINTAINED PER CITY OF GREENVILLE STANDARDS AND THE MANUAL FOR UNIFORM TRAFFIC CONTROL DEVICES, (MUTCD) LATEST EDITION.
- 5. TRAFFIC-RATED GRATING OR EQUAL MEANS SHALL BE PROVIDED TO ALLOW FOR CONTINUAL VEHICULAR AND PEDESTRIAN ACCESS TO ALL RESIDENTIAL PROPERTIES THROUGHOUT CONSTRUCTION.
- 6. CITY TO COORDINATE WITH TENANTS AT 1725 AND 1801 CEDAR LN TO PARK AT SCHOOL PARKING LOT DURING PORTIONS OF PHASE 2 CONSTRUCTION WHERE ACCESS IS REMOVED FROM PARKING LOTS.

PLAN
SCALE: 1" = 100'

PROJECT ENGINEER:

DESIGNED BY:

C. WILSON

DRAWN BY:

S. KANE

CHECKED BY:

M. SANTOWASSO

IF THIS BAR DOES NOT MEASURE 1" THEN DRAWING IS NOT TO FULL SCALE

REV ISSUED FOR DATE BY

REV ISSUED FOR DATE BY

FINAL DESIGN DO NOT USE
FOR CONSTRUCTION
Digitally signed by Continue E.
Wilson
Date: 2021.12.28 15:03:40-05'00'



LICENSE NO.: C-0381


CITY OF GREENVILLE GREENVILLE, NORTH CAROLINA

CEDAR LANE DRAINAGE IMPROVEMENTS

CIVIL
TRAFFIC CONTROL PLAN - PHASE 2

DATE: JANUARY 2022
HAZEN NO.: 31187-003
CONTRACT NO.:
DRAWING NUMBER:
C14

1" = 100'

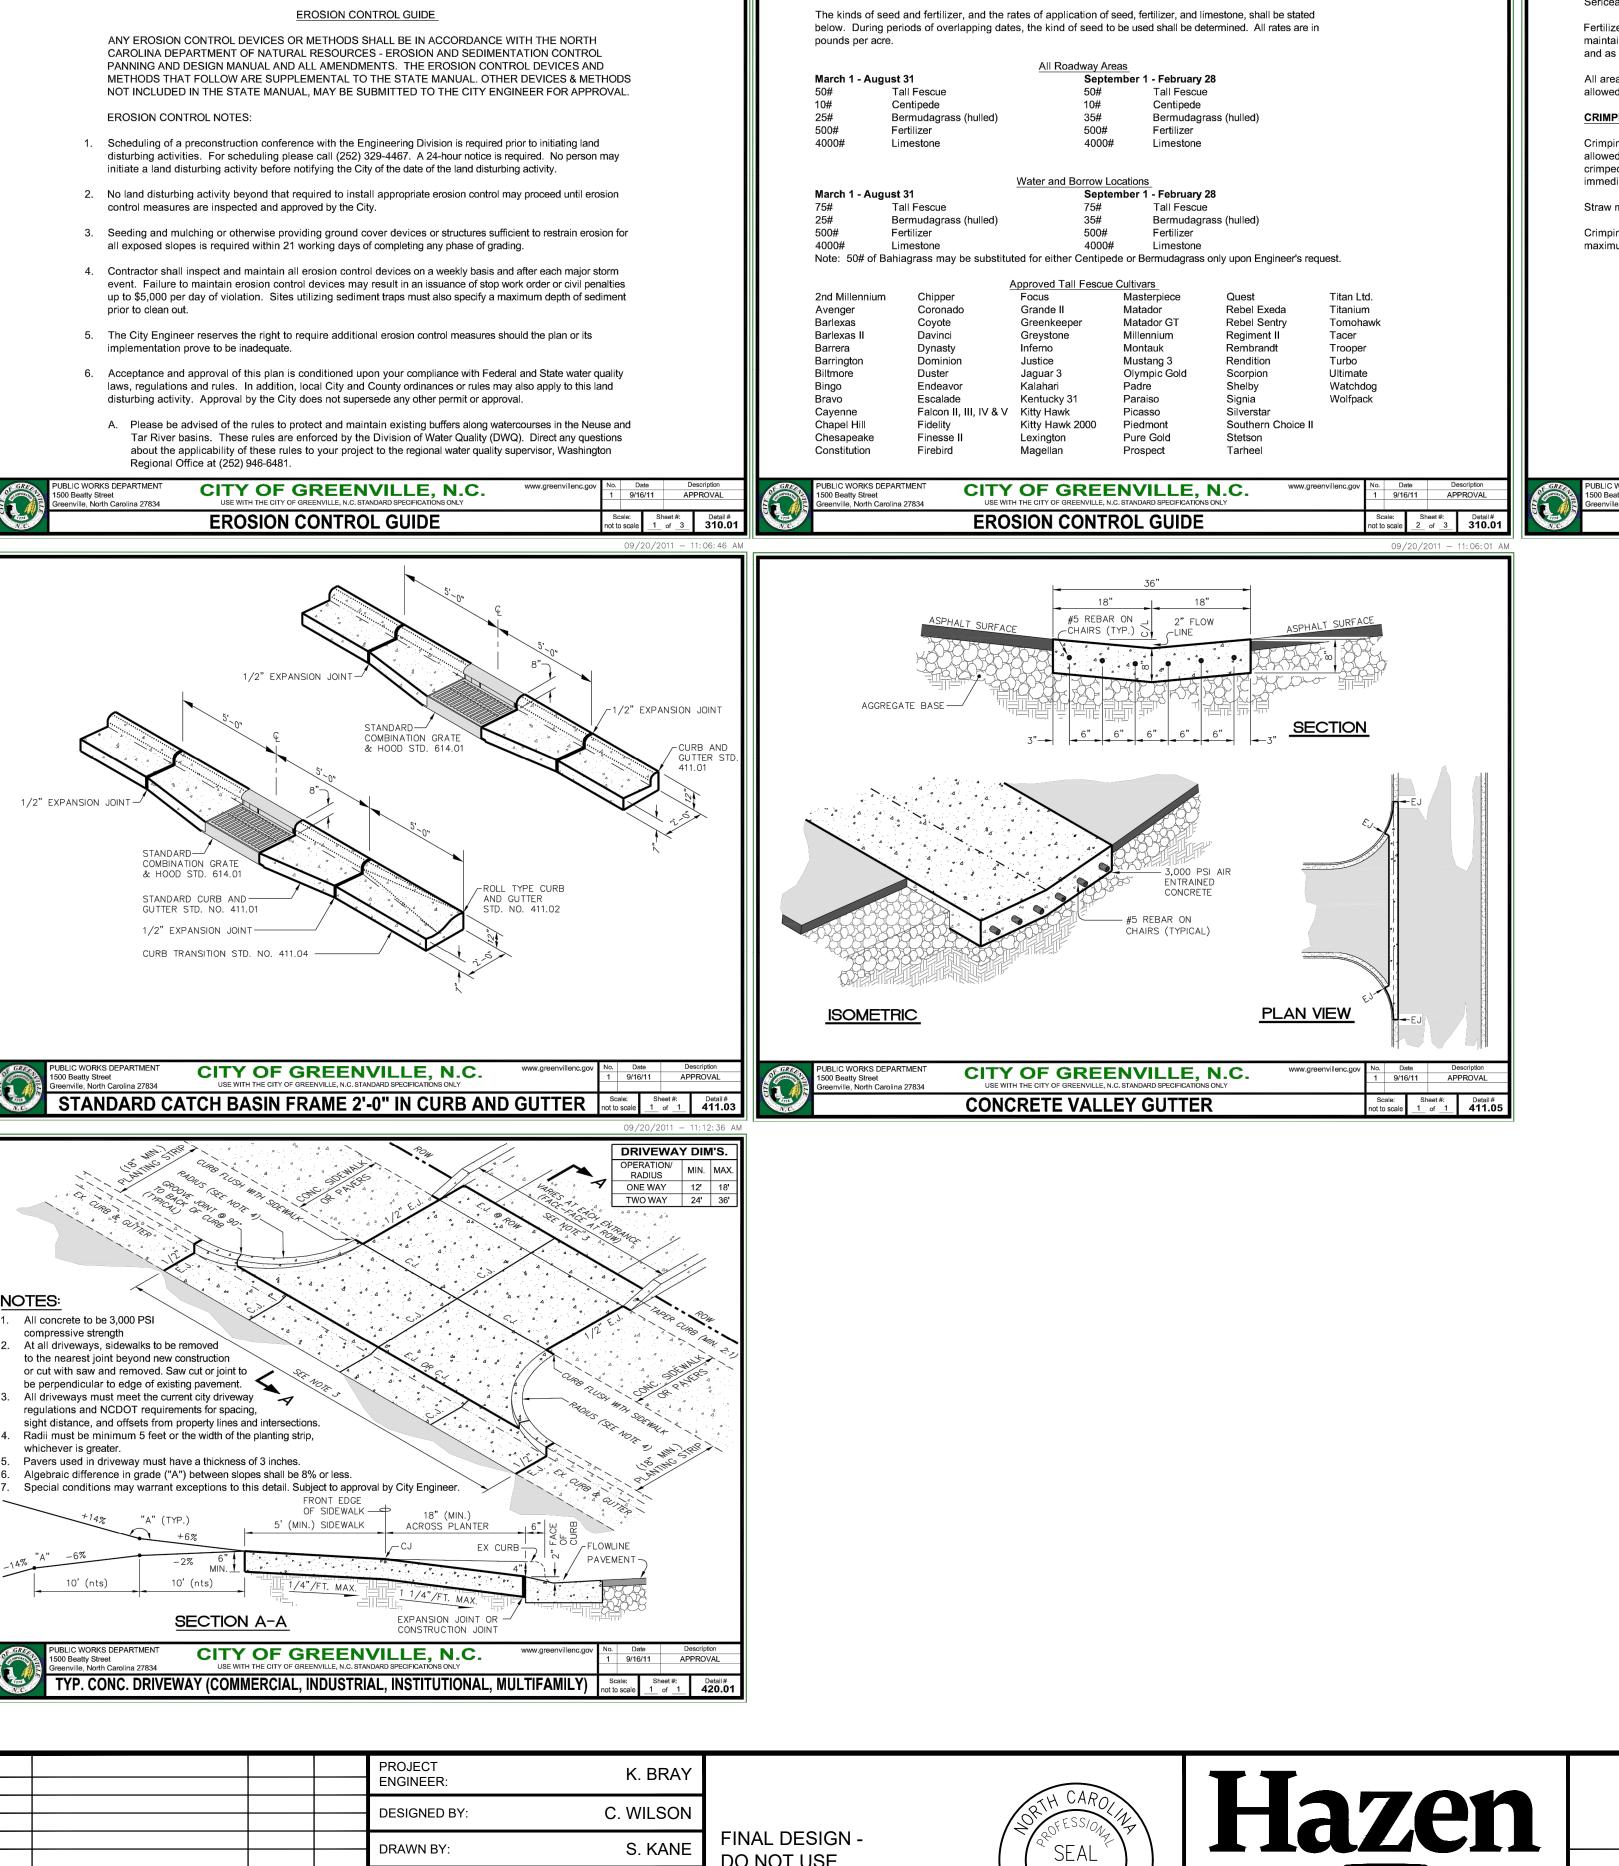

SEEDING AND MULCHING:

On cut and fill slopes 2:1 or steeper Centipede shall be applied at a rate of 5 pounds per acre and add 20# of Sericea Lespedeza from January 1 - December 21.

Fertilizer shall be 10-20-20 analysis. A different analysis of fertilizer may be used provided the 1-2-2 ratio is maintained and the rate of application adjusted to provide the same amount of plant food as a 10-20-20 analysis

All areas seeded and mulched shall be tacked with asphalt. Crimping of straw in lieu of asphalt tack shall not be allowed on projects.

#### CRIMPING STRAW MULCH:


Crimping shall be required on projects adjacent to any section of roadway where traffic is to be maintained or allowed during construction. In areas within six feet of the edge of pavement, straw is to be applied and then crimped. After the crimping operation is complete, an additional application of straw shall be applied and immediately tacked with a sufficient amount of undiluted emulsified asphalt.

Straw mulch shall be sufficient length and quality to withstand the crimping operation.

Crimping equipment including power source shall be subject to the approval of the Engineer providing that maximum spacing of crimper blades shall not exceed 8".

CITY OF GREENVILLE, N.C.

**EROSION CONTROL GUIDE** 

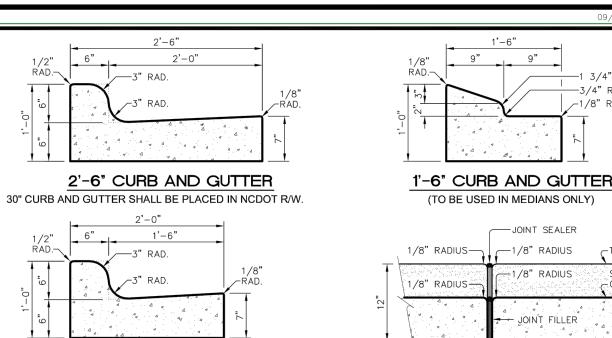

2'-0' CURB AND GUTTER 24" CURB AND GUTTER SHALL BE PLACED IN RESIDENTIAL DEVELOPMENTS OR AS PROVIDED IN SEC. 490 OF THIS MANUAL.

TRANSVERSE EXPANSION JOINT IN CURB AND GUTTER

Contraction joints shall be placed at 10' intervals, except that 15' spacing may be used when a machine is used or when satisfactory support for the face form can be obtained without the use of templates at 10' intervals. Joint spacing may be altered by the engineer to prevent uncontrolled cracking.

Contraction joints may be installed by the use of templates or formed by other approved methods. Where such joints are not formed by templates, a

-3/4" RAD.

SURFACE

1/2"

OF GUTTER

minimum depth of 1 1/2" shall be obtained All contraction joints shall be filled with joint filler.

Expansion joints shall be spaced at 90' intervals, and adjacent to all rigid objects. All curb and gutters are to be poured with class "A" concrete (3,000 PSI).

Flexible forms are to be used when radius is less than 200'

CITY OF GREENVILLE, N.C. STANDARD CURB & GUTTER Scale: Sheet #: Detail #
not to scale 1 of 1 **411.01** 

#### **CURB RAMP AND EXISTING SIDEWALK**

- 1. CONSTRUCT THE RAMP SURFACE TO BE STABLE, FIRM, AND SLIP RESISTANT. CONSTRUCT THE CURB RAMP TYPE AS SHOWN IN THE PAVEMENT MARKING PLANS OR AS DIRECTED BY THE ENGINEER.
- 2. LOCATE CURB RAMPS AND PLACE PEDESTRIAN CROSSWALK MARKINGS AS SHOWN IN THE PAVEMENT MARKING PLANS. WHEN FIELD ADJUSTMENTS REQUIRE MOVING CURB RAMPS OR MARKINGS AS SHOWN, CONTACT THE SIGNING AND DELINEATION UNIT OR LOCATE AS DIRECTED BY THE ENGINEER.
- 3. COORDINATE THE CURB RAMP AND THE PEDESTRIAN CROSSWALK MARKINGS SO A 4'x4' CLEAR SPACE AT THE BASE OF THE CURB RAMP WILL FALL WITHIN THE PEDESTRIAN CROSSWALK LINES.
- 4. SET BACK DISTANCE FROM INSIDE CROSSWALK MARKING TO NEAREST EDGE OF TRAVEL LANE IS 4' MINIMUM.
- 5. REFER TO THE PAVEMENT MARKING PLANS FOR STOP BAR LOCATIONS AT SIGNALIZED INTERSECTIONS. IF A PAVEMENT MARKING PLAN IS NOT PROVIDED, CONTACT THE SIGNAL DESIGN SECTION FOR THE STOP BAR LOCATIONS OR LOCATE AS DIRECTED BY THE ENGINEER.
- 6. TERMINATE PARKING A MINIMUM OF 20' BACK OF A PEDESTRIAN CROSSWALK.
- 7. CONSTRUCT CURB RAMPS A MINIMUM OF 4' WIDE.
- 8. CONSTRUCT THE RUNNING SLOPE OF THE RAMP 8.33% MAXIMUM
- 9. ALLOWABLE CROSS SLOPE ON SIDEWALKS AND CURB RAMPS WILL BE 2% MAXIMUM.
- 10. CONSTRUCT THE SIDE FLARE SLOPE A MAXIMUM OF 10% MEASURED ALONG THE CURB LINE.
- 11. CONSTRUCT THE COUNTER SLOPE OF THE GUTTER OR STREET AT THE BASE OF THE CURB RAMP A MAXIMUM OF 5% AND MAINTAIN A
- 12. CONSTRUCT LANDINGS FOR SIDEWALK A MINIMUM OF 4'x4' WITH A MAXIMUM SLOPE OF 2% IN ANY DIRECTION. CONSTRUCT LANDINGS FOR MEDIAN ISLANDS A MINIMUM OF 5'x5' WITH A MAXIMUM SLOPE OF 2% IN ANY DIRECTION. 13. TO USE A MEDIAN ISLAND AS A PEDESTRIAN REFUGE AREA, MEDIAN ISLANDS WILL BE A MINIMUM OF 6' WIDE. CONSTRUCT MEDIAN ISLANDS
- TO PROVIDE PASSAGE OVER OR THROUGHT THE ISLAND. 14. SMALL CHANNELIZATION ISLANDS THAT CAN NOT PROVIDE A 5'X5' LANDING AT THE TOP OF A RAMPS, WILL BE CUT THROUGH LEVEL WITH
- 15. CURB RAMPS WITH RETURNED CURBS MAY BE USED ONLY WHERE PEDESTRIANS WOULD NOT NORMALLY WALK ACROSS THE RAMP. THE ADJACENT SURFACE IS PLANTING OR OTHER NON-WALKING SURFACE OR THE SIDE APPROACH IS SUBSTANTIALLY OBSTRUCTED.
- 16. PLACE A ½" EXPANSION JOINT WHERE THE CONCRETE CURB RAMP JOINS THE CURB AS SHOWN IN ROADWAY STANDARD DRAWING 848.01
- 17. PLACE ALL PEDESTRIAN PUSH BUTTON ACTUATORS AND CROSSING SIGNALS AS SHOWN IN THE PLANS OR AS SHOWN IN THE MUTCD.
- 18. CURB RAMPS THROUGH MEDIAN ISLANDS, SINGLE RAMPS AT DUAL CROSSWALKS OR LIMITED R/W SITUATIONS, WILL BE HANDLED BY SPECIAL DETAILS. CONTACT THE CONTRACT STANDARDS AND DEVELOPMENT UNIT FOR THE DETAILS OR FOR A SPECIAL DESIGN.

SEE DWG CD2 FOR CONTINUATION OF NCDOT STD DETAIL 848.06.

BTHARRINGTON					PROJECT K. BRAY
BY: BTHAF					DESIGNED BY: C. WILSON
9:48 AM B					DRAWN BY: S. KANE
12/28/2021 9:4					CHECKED BY: M. SANTOWASSO
DATE: 12/28					IF THIS BAR DOES NOT  MEASURE 1" THEN DRAWING IS  1"
.π DA	RE\/	ISSUED FOR	DATE	BV	NOT TO FULL SCALE

**SEDIMENTATION AND EROSION CONTROL** 

DO NOT USE

044600 Digitally signed by Wrinnew Wilson Date: 2021.12.28 15:03:45-05'00'

HAZEN AND SAWYER 4011 WESTCHASE BOULEVARD, SUITE 500

CITY OF GREENVILLE GREENVILLE, NORTH CAROLINA

THE SURFACE STREET.

CEDAR LANE DRAINAGE **IMPROVEMENTS** 

CIVIL STANDARD DETAILS - SHEET 1


JANUARY 2022 31187-003 HAZEN NO.: CONTRACT NO. **DRAWING** NUMBER: CD1


SHEET 5 OF 5 848.06

FOR CONSTRUCTION


RALEIGH, NORTH CAROLINA 27607

LICENSE NO.: C-0381

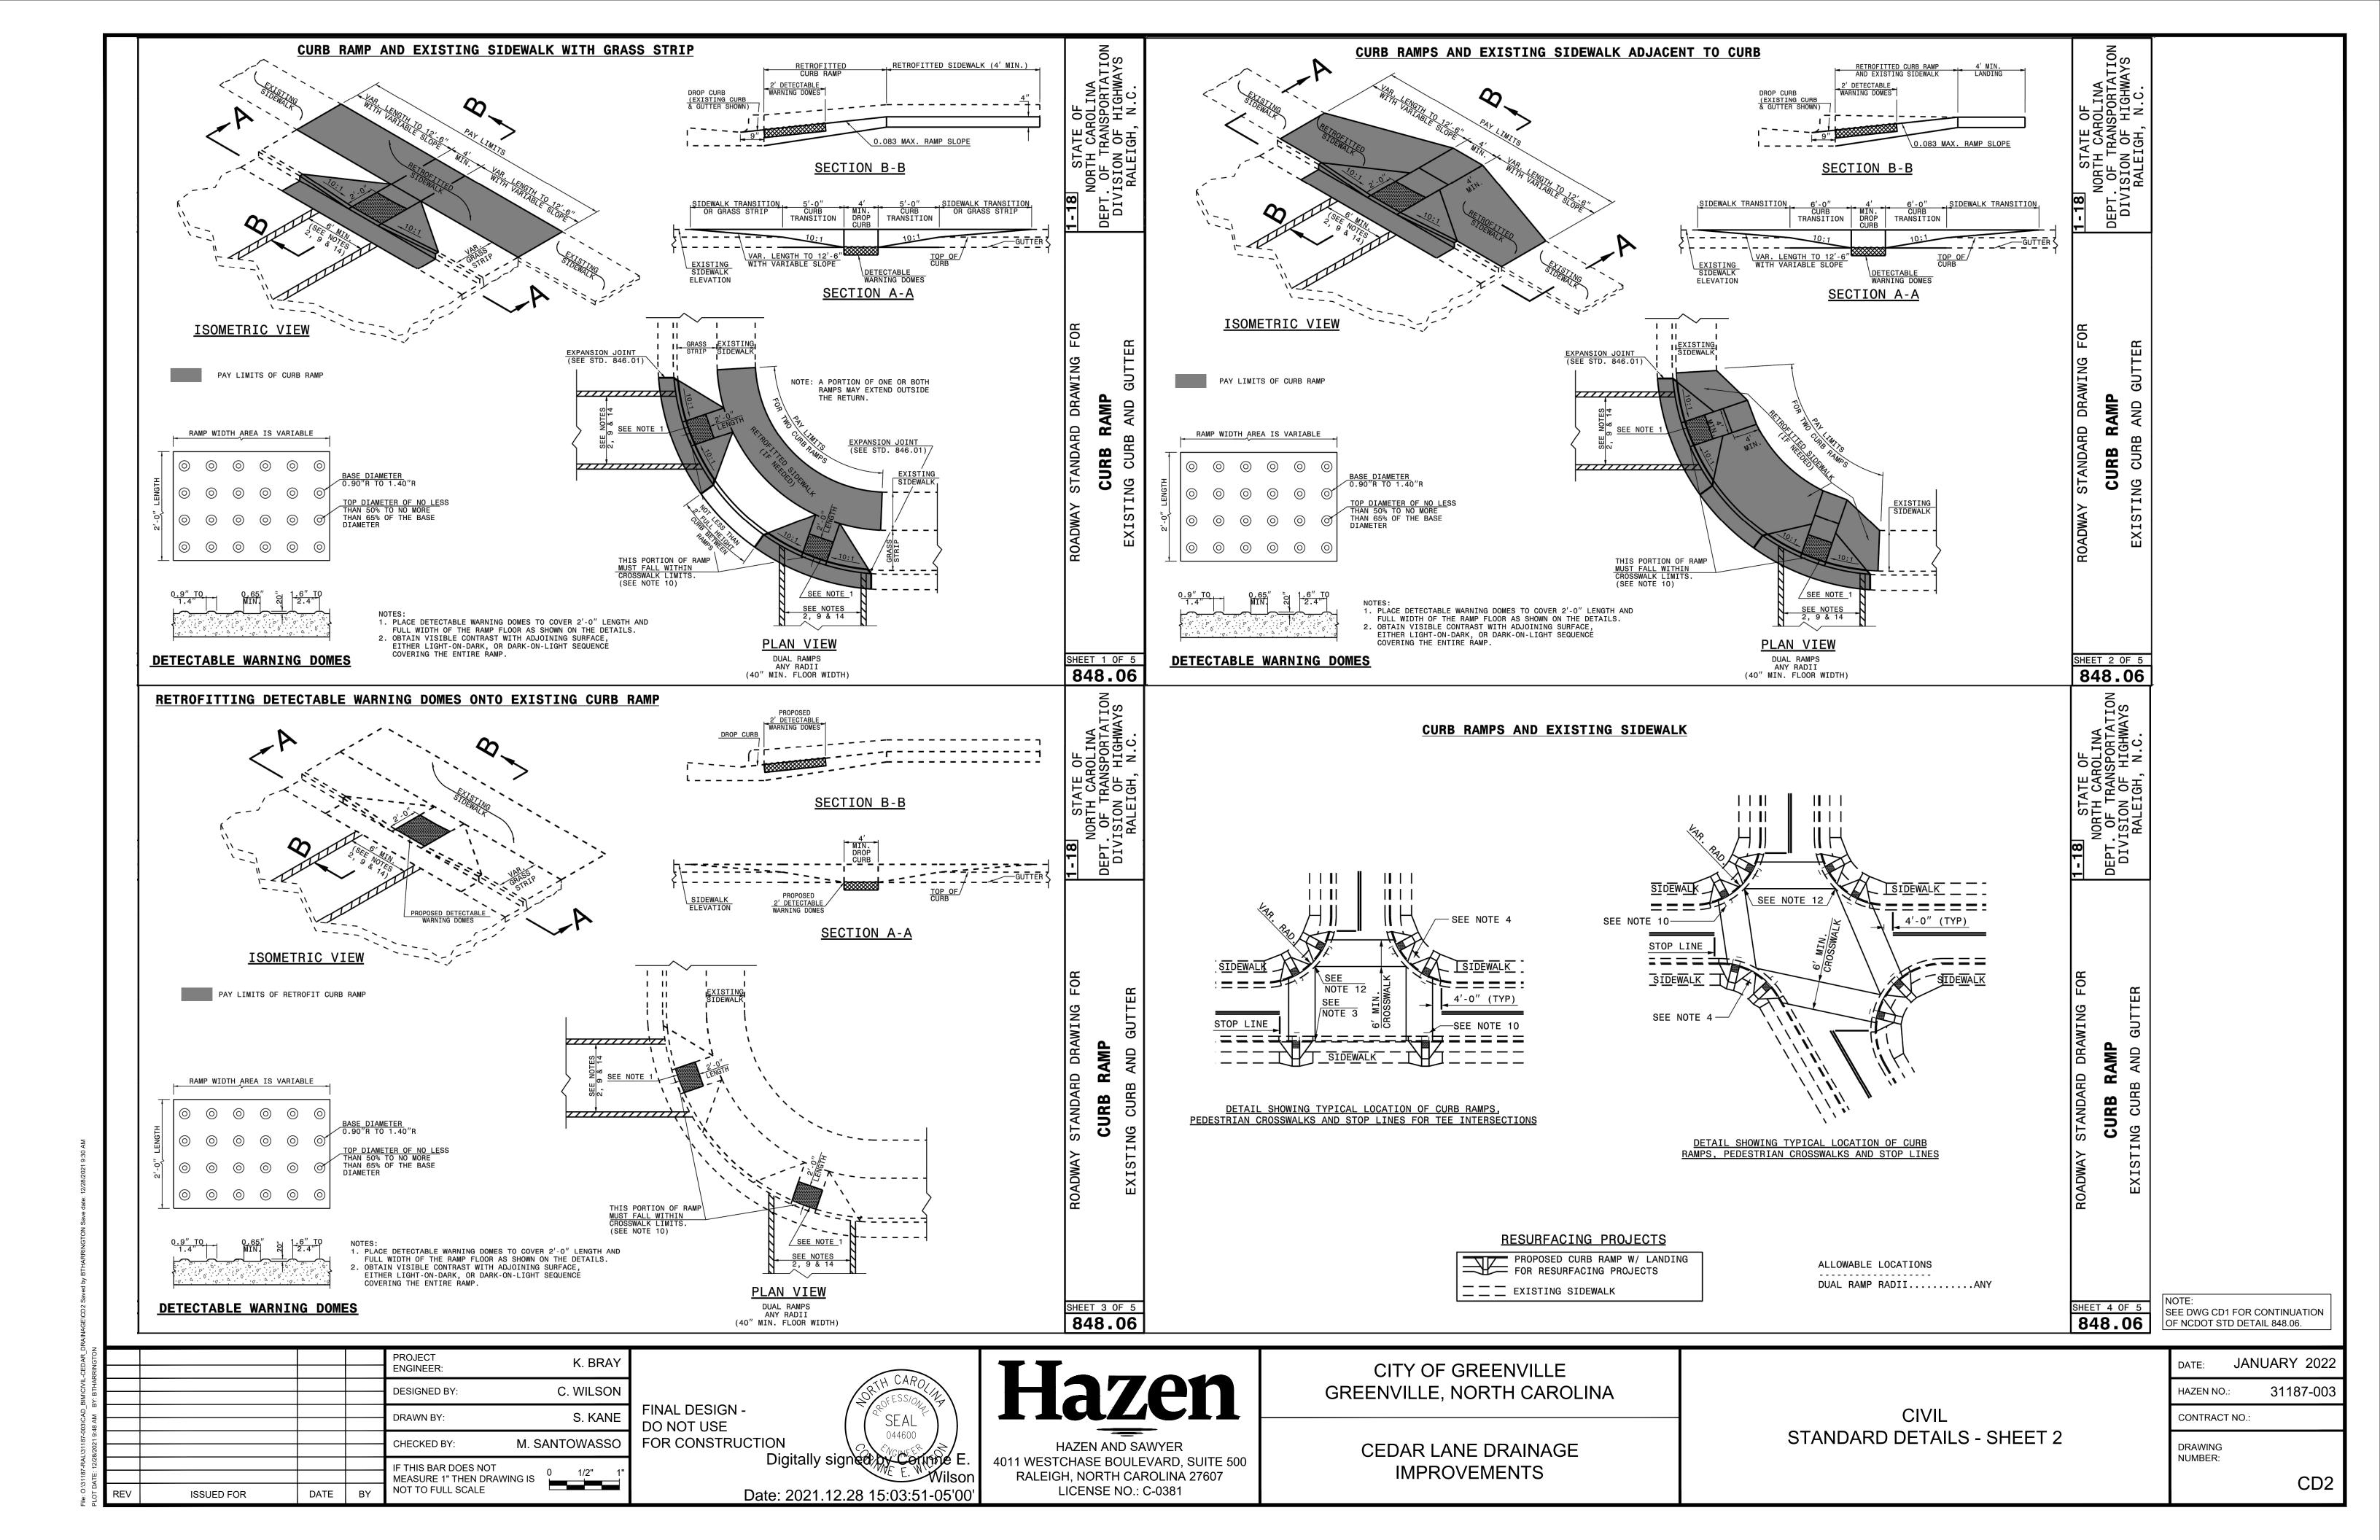

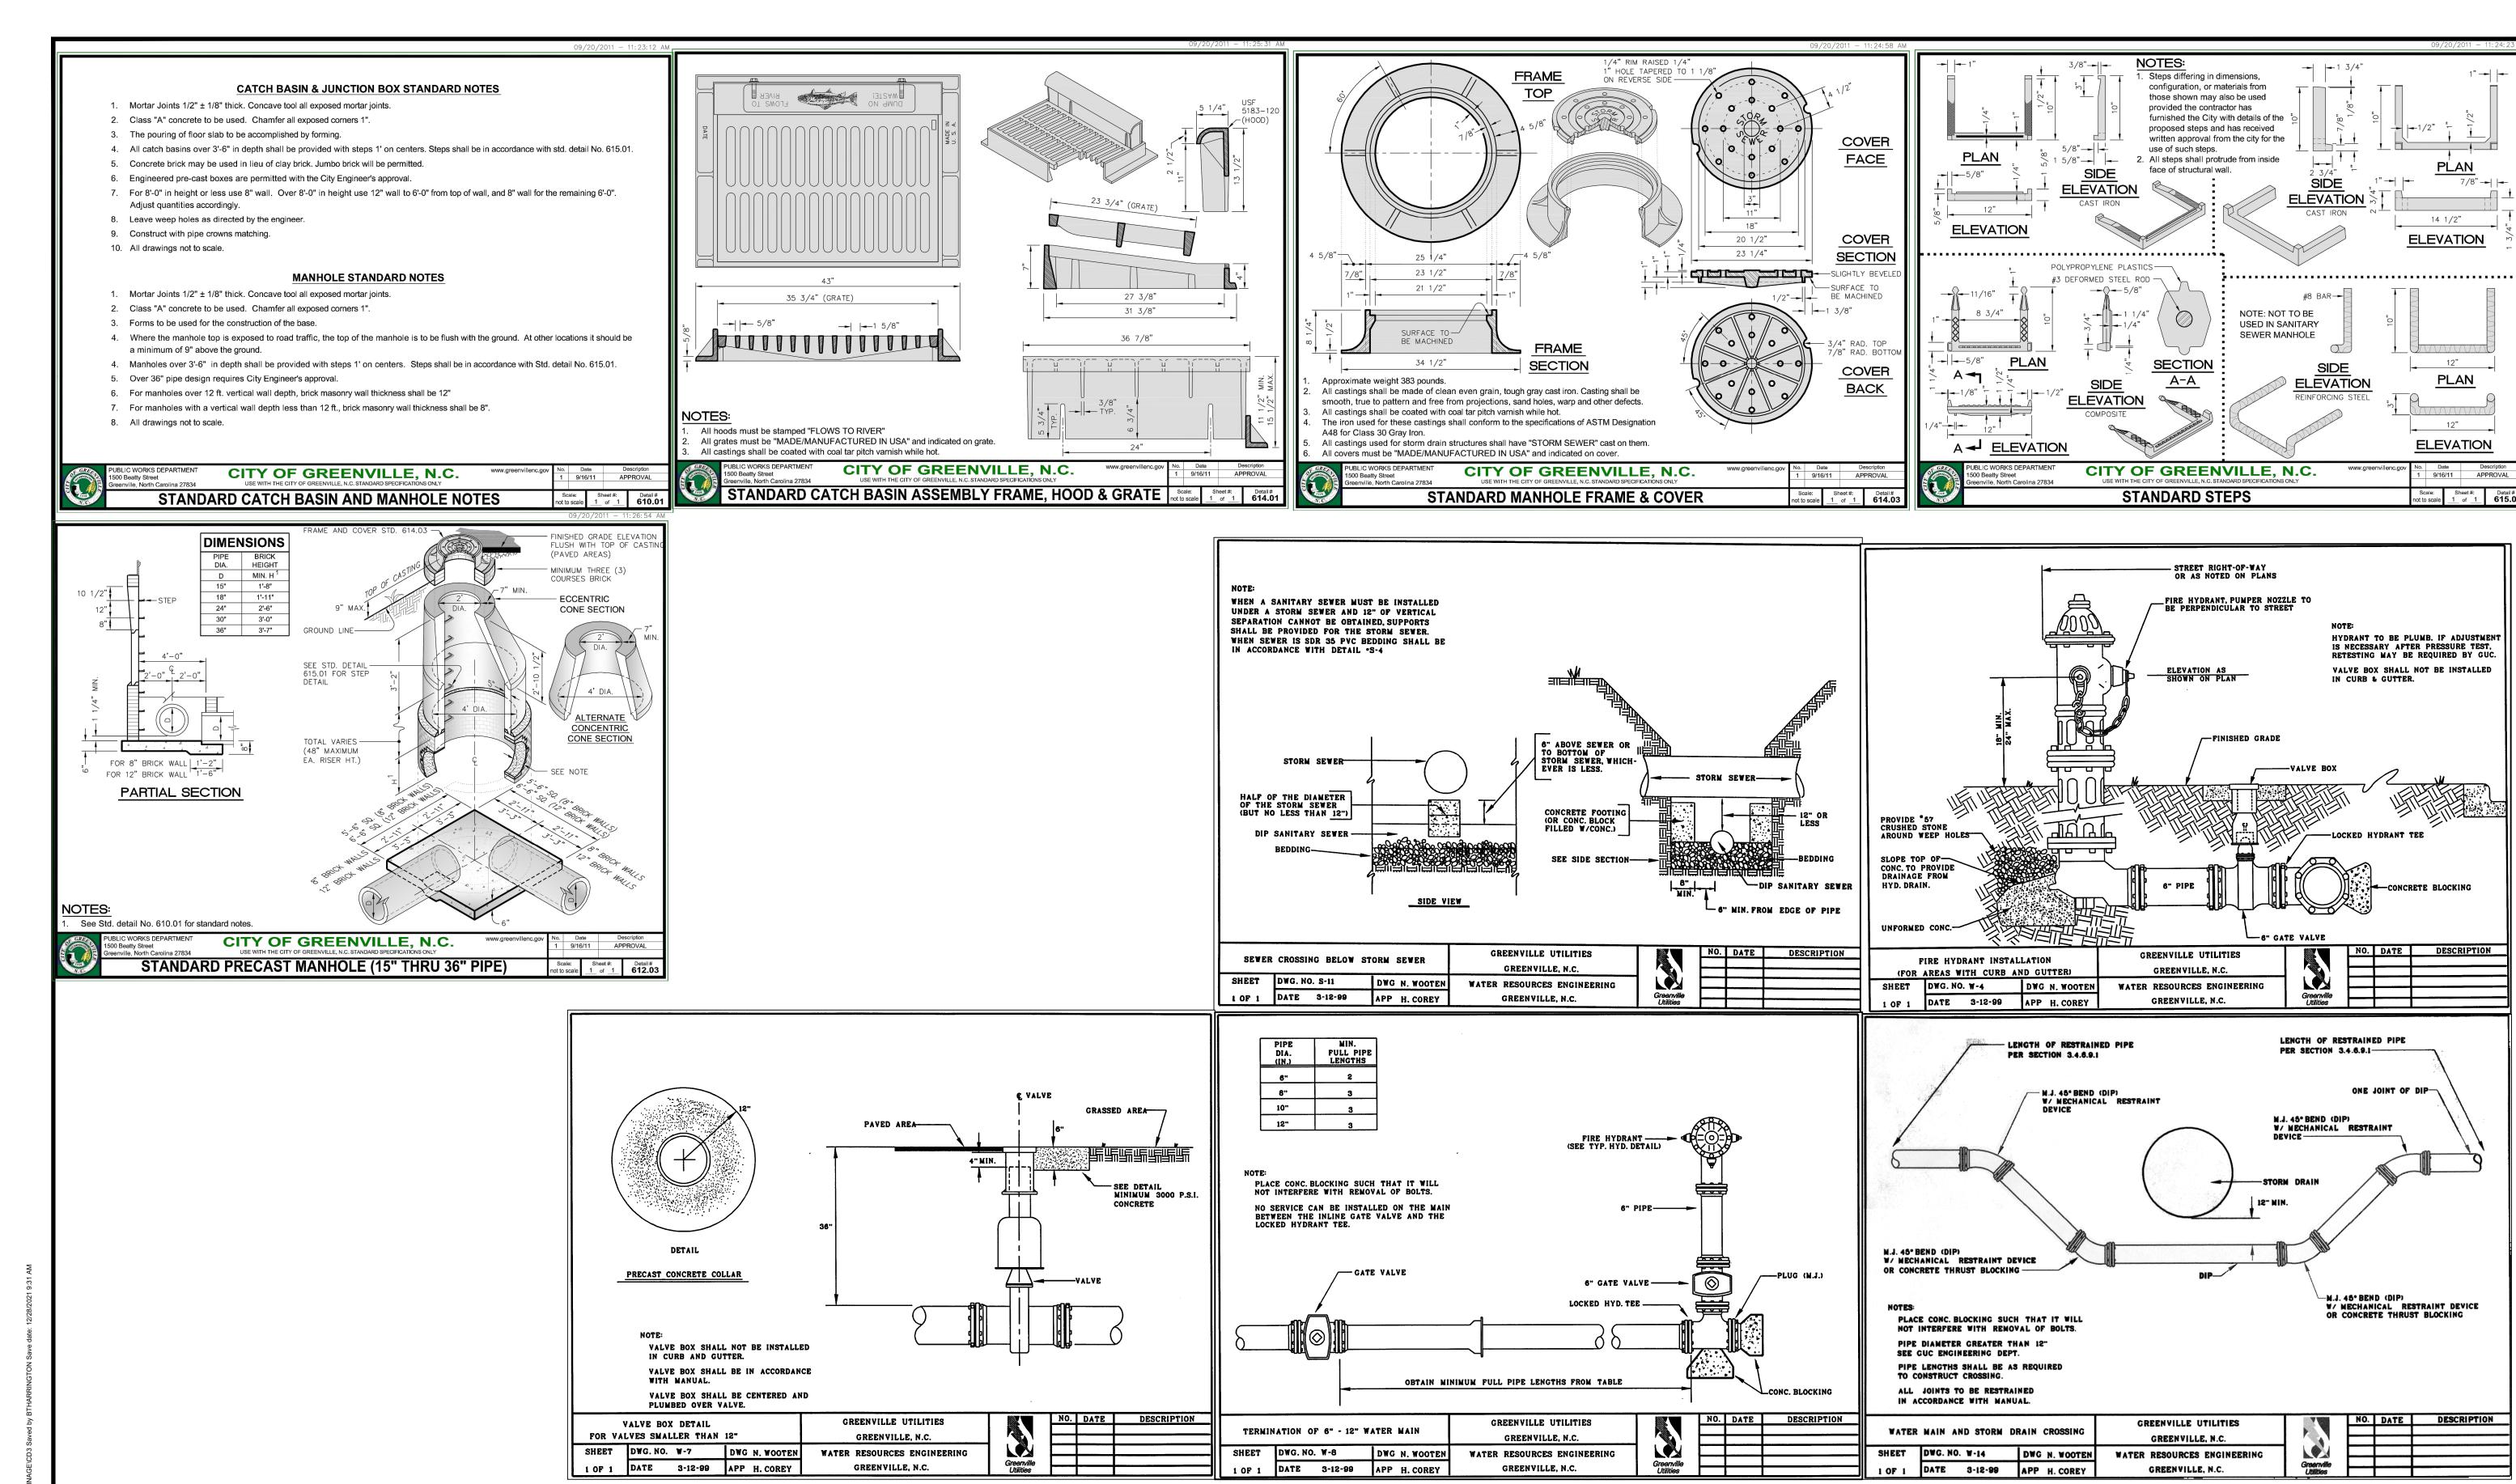

BY: BTHARRINGTON					PROJECT K. BRAY	
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HAZEN AND SAWYER

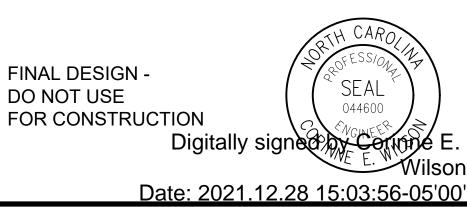4011 WESTCHASE BOULEVARD, SUITE 500

RALEIGH, NORTH CAROLINA 27607 LICENSE NO.: C-0381

CITY OF GREENVILLE GREENVILLE, NORTH CAROLINA

> CEDAR LANE DRAINAGE **IMPROVEMENTS**

CIVIL STANDARD DETAILS - SHEET 3

Greenville Utilities	
	DATE: JANUARY 2022
	HAZEN NO.: 31187-003
	CONTRACT NO.:
	DRAWING NUMBER:
	CD3

7/8"→| |←

14 1/2"

**ELEVATION** 

<u>PLAN</u>

**ELEVATION** 

HYDRANT TO BE PLUMB. IF ADJUSTMENT

IS NECESSARY AFTER PRESSURE TEST, RETESTING MAY BE REQUIRED BY GUC.

VALVE BOX SHALL NOT BE INSTALLED

IN CURB & GUTTER.

Scale: Sheet #: Detail # to scale 1 of 1 615.01

**ELEVATION** 

**ELEVATION** 

REINFORCING STEEL

NOTE: NOT TO BE

SEWER MANHOLE

USED IN SANITARY

--- 6" GATE VALVE

LENGTH OF RESTRAINED PIPE


ONE JOINT OF DIP-

-M.J. 45° BEND (DIP)

W/ MECHANICAL RESTRAINT DEVICE
OR CONCRETE THRUST BLOCKING

PER SECTION 3.4.6.9.1-

M.J. 45° BEND (DIP) W/ Mechanical restraint

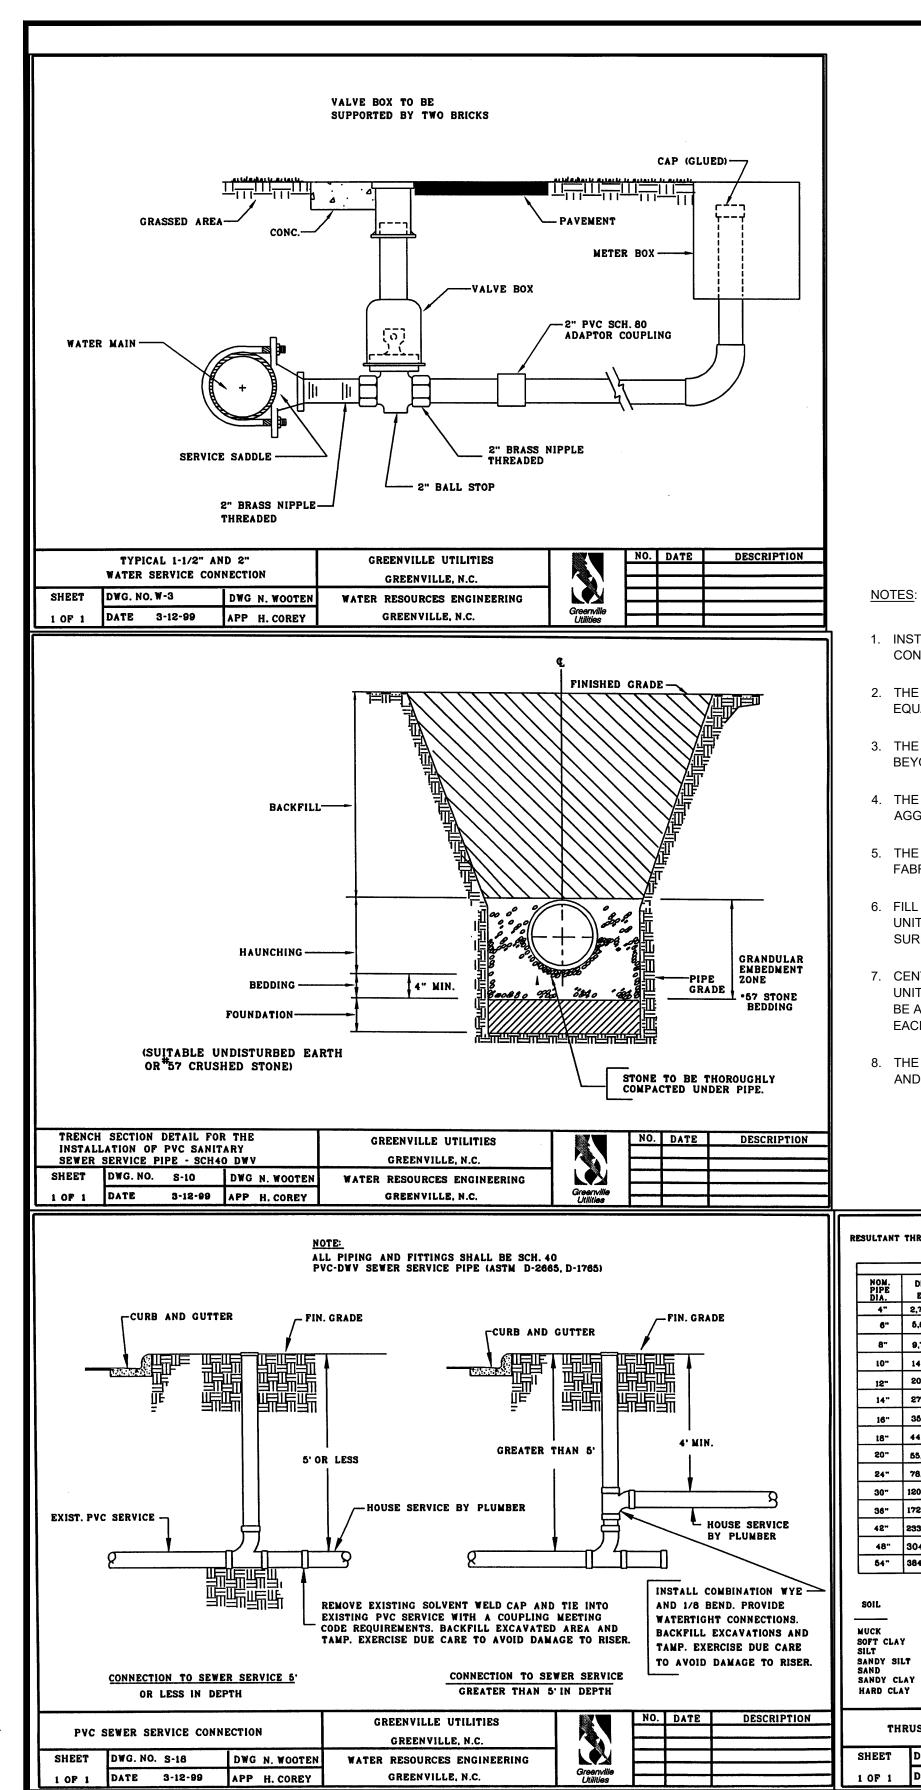

PROJECT

**ENGINEER**:

DRAWN BY:


CHECKED BY

ISSUED FOR

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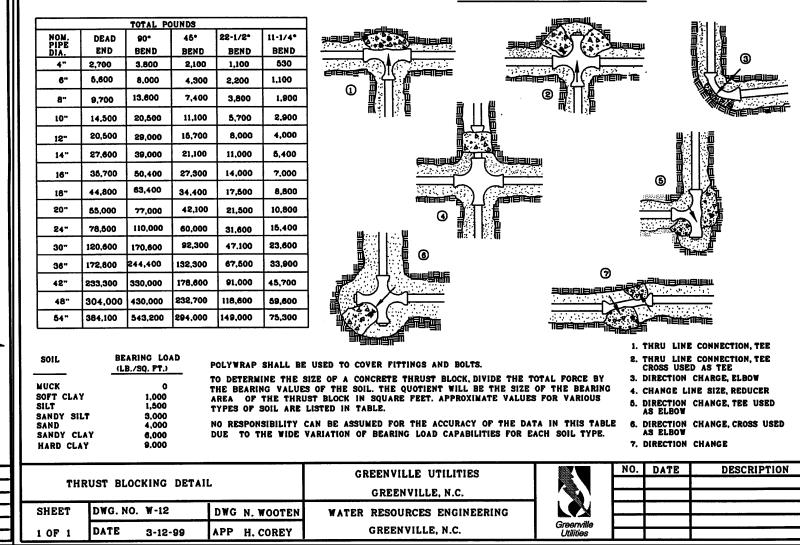
IF THIS BAR DOES NOT MEASURE 1" THEN DRAWING IS


DESIGNED BY:

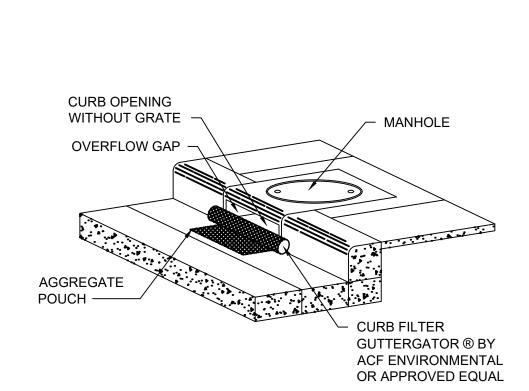

- 1. INSTALL CURB FILTERS AT ALL INLETS WITHOUT GRATES TO KEEP SILT, SEDIMENT AND CONSTRUCTION DEBRIS OUT OF THE STORM SYSTEM.
- 2. THE CURB FILTER SHALL BE DANDY CURB AS MANUFACTURED BY DANDY PRODUCTS INC., OR EQUAL. SUBMIT SHOP A SHOP DRAWING FOR THE CURB FILTERS.
- 3. THE CURB FILTER SHALL FORM OF A CYLINDRICAL TUBE PLACED IN FRONT OF AND EXTENDING BEYOND THE INLET OPENING ON BOTH SIDES.
- 4. THE CURB FILTER SHALL HAVE A POUCH ON THE STREET SIDE OF THE UNIT FOR STONE AGGREGATE TO HOLD THE FILTER IN PLACE.
- 5. THE CURB FILTER SHALL BE CONSTRUCTED OF A HIGH VISIBILITY ORANGE MONOFILAMENT
- 6. FILL POUCH WITH #57 STONE AGGREGATE TO A LEVEL (AT LEAST HALF-FULL) THAT WILL KEEP UNIT IN PLACE DURING A RAIN EVENT AND CREATE A SEAL BETWEEN THE CURB FILTER AND THE SURFACE OF THE STREET.
- 7. CENTER THE UNIT AGAINST CURB OR MEDIAN INLET OPENING SO THAT THE CURB SIDE OF THE UNIT CREATES A SEAL WITH THE CURB OR MEDIAN BARRIER AND INLET STRUCTURE. THERE WILL BE APPROXIMATELY TWELVE (12) INCHES OF THE INLET PROTECTION UNIT OVERHANGING ON EACH SIDE OF THE OPENING.
- 8. THE CONTRACTOR SHALL REMOVE ALL ACCUMULATED SEDIMENT AND DEBRIS FROM SURFACE AND VICINITY OF UNIT AFTER EACH RAIN EVENT.

#### **CURB INLET PROTECTION** C-31-0414



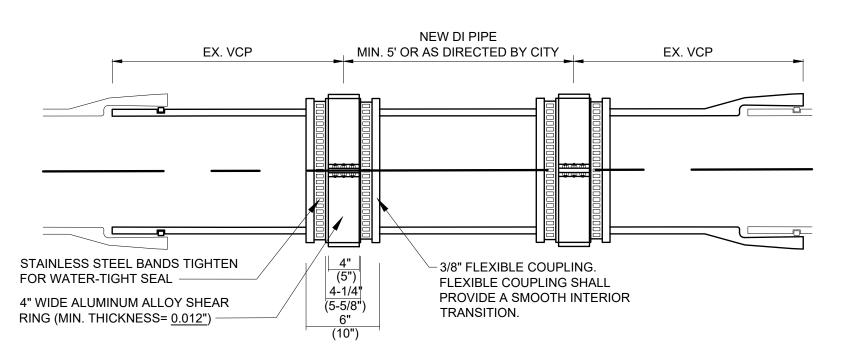

## NOTES:

- 1. ALL CONSTRUCTION MATERIALS SHALL BE IN ACCORDANCE WITH PROJECT SPECIFICATIONS.
- 2. CONTRACTOR SHALL PROVIDE ALL NECESSARY PUMPS, HEADER PIPE, PUMPING EQUIPMENT, ETC. PRIOR TO BEGINNING CONSTRUCTION. DUPLICATE SEWAGE HANDLING PUMPS, PIPING, ETC. SHALL BE ON-SITE AND AVAILABLE FOR IMMEDIATE USE SHOULD PRIMARY PUMP OR FORCE MAIN FAIL. INSURE PUMPS, HEADER PIPING, ETC. ARE PROPERLY SIZED AND OPERATIONAL BEFORE BEGINNING WORK.
- PIPE REPAIR SHALL EXHIBIT STRAIGHT HORIZONTAL ALIGNMENT AND INVERT SHALL BE THE SAME AS THE EXISTING PIPE SLOPE. DEFLECTIONS OF HORIZONTAL AND VERTICAL ALIGNMENT ARE NOT ACCEPTABLE.
- 4. PIPE SHALL BE BACKFILLED AND COMPACTED AND PROPERLY BEDDED IN ACCORDANCE WITH THE CONTRACT
- THERE SHALL BE NO MORE THAN 1/4" SPACE BETWEEN THE EXISTING SEWER MAIN AND THE REPLACEMENT PIPE AT EACH END.

DAMAGED SECTION SHALL BE CUT OUT WITHOUT

DAMAGING THE PIPE TO REMAIN.


7. DI SEWER PIPE AND FITTINGS SHALL HAVE AN INTERIOR COATING OF PROTECTO 401 OR APPROVED EQUAL.

SEDIMENT LOG

(FFT), TYP

SEE DETAIL A

SEE DETAIL A

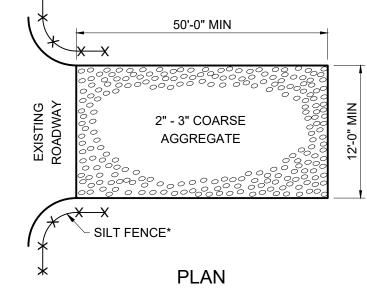


CONSTRUCTION ENTRANCE IS USED. IF CONSTRUCTION ON THE SITES ARE SUCH THAT THE MUD IS NOT REMOVED BY THE VEHICLE TRAVELING OVER THE STONE, THEN THE TIRES OF THE VEHICLE MUST BE WASHED BEFORE ENTERING THE PUBLIC ROAD OR THE LENGTH OF

1. \*SILT FENCE SHOULD BE INSTALLED TO ENSURE

MAINTENANCE: ADD ADDITIONAL STONE AND "FLUFF" TOP DRESSING WITH 2" STONE.

THE CONSTRUCTION ENTRANCE EXTENDED.

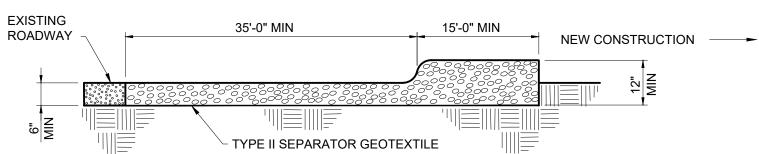

#### CROSS SECTION

SEE N.C. DENR EROSION AND SEDIMENT CONTROL PLANNING and DESIGN MANUAL FOR CONDITIONS WHERE PRACTICE APPLIES; PLANNING CONSIDERATION & DESIGN CRITERIA.

#### GRAVEL ENTRANCE/EXIT


C-31-0490

## VCP TO DIP PIPE CONNECTION

DETAIL	1	
SCALE: NTS	CD4	

#### MAINTENANCE REQUIREMENTS:

- INSPECT WEEKLY AND AFTER EACH RAINFALL EVENT THAT PRODUCES 1/2 INCH OR MORE OF RAIN. REMOVE ANY ACCUMULATED SEDIMENT AND/OR WOODY DEBRIS.
- FFTs SHALL BE ENTRENCHED AS SHOWN TO PREVENT UNDERCUTTING. ANY EVIDENCE OF UNDERCUTTING AND/OR EROSION SHALL BE REPAIRED IMMEDIATELY.
- STAKES AND/OR STAPLES THAT HAVE BECOME LOOSE OR DISPLACED SHALL BE REPAIRED IMMEDIATELY.
- WHEN SEDIMENT ACCUMULATION REACHES 1/2 THE DIAMETER OF THE FFT, IT SHALL BE REMOVED AND DISPOSED OFF-SITE BY THE CONTRACTOR IN ACCORDANCE WITH ALL STATE AND LOCAL

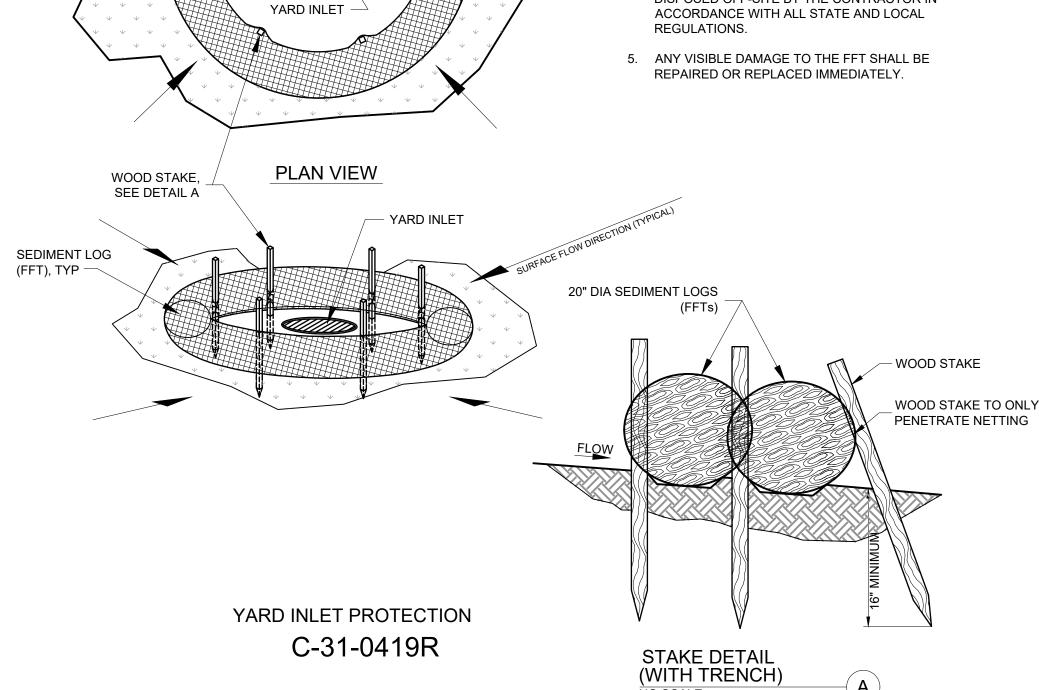



K. BRAY

S. KANE

C. WILSON

M. SANTOWASSO

FINAL DESIGN -SEAL DO NOT USE FOR CONSTRUCTION Digitally signed by Corinne E Date: 2021.12.28 15:04:01-05'00 HAZEN AND SAWYER

4011 WESTCHASE BOULEVARD, SUITE 500

RALEIGH, NORTH CAROLINA 27607


LICENSE NO.: C-0381


CITY OF GREENVILLE GREENVILLE, NORTH CAROLINA


> CEDAR LANE DRAINAGE **IMPROVEMENTS**


CIVIL STANDARD DETAILS - SHEET 4


DATE:	JANUARY	2022
HAZEN NO.:	3118	7-003
CONTRACT	NO.:	
DRAWING NUMBER:		
		CD4

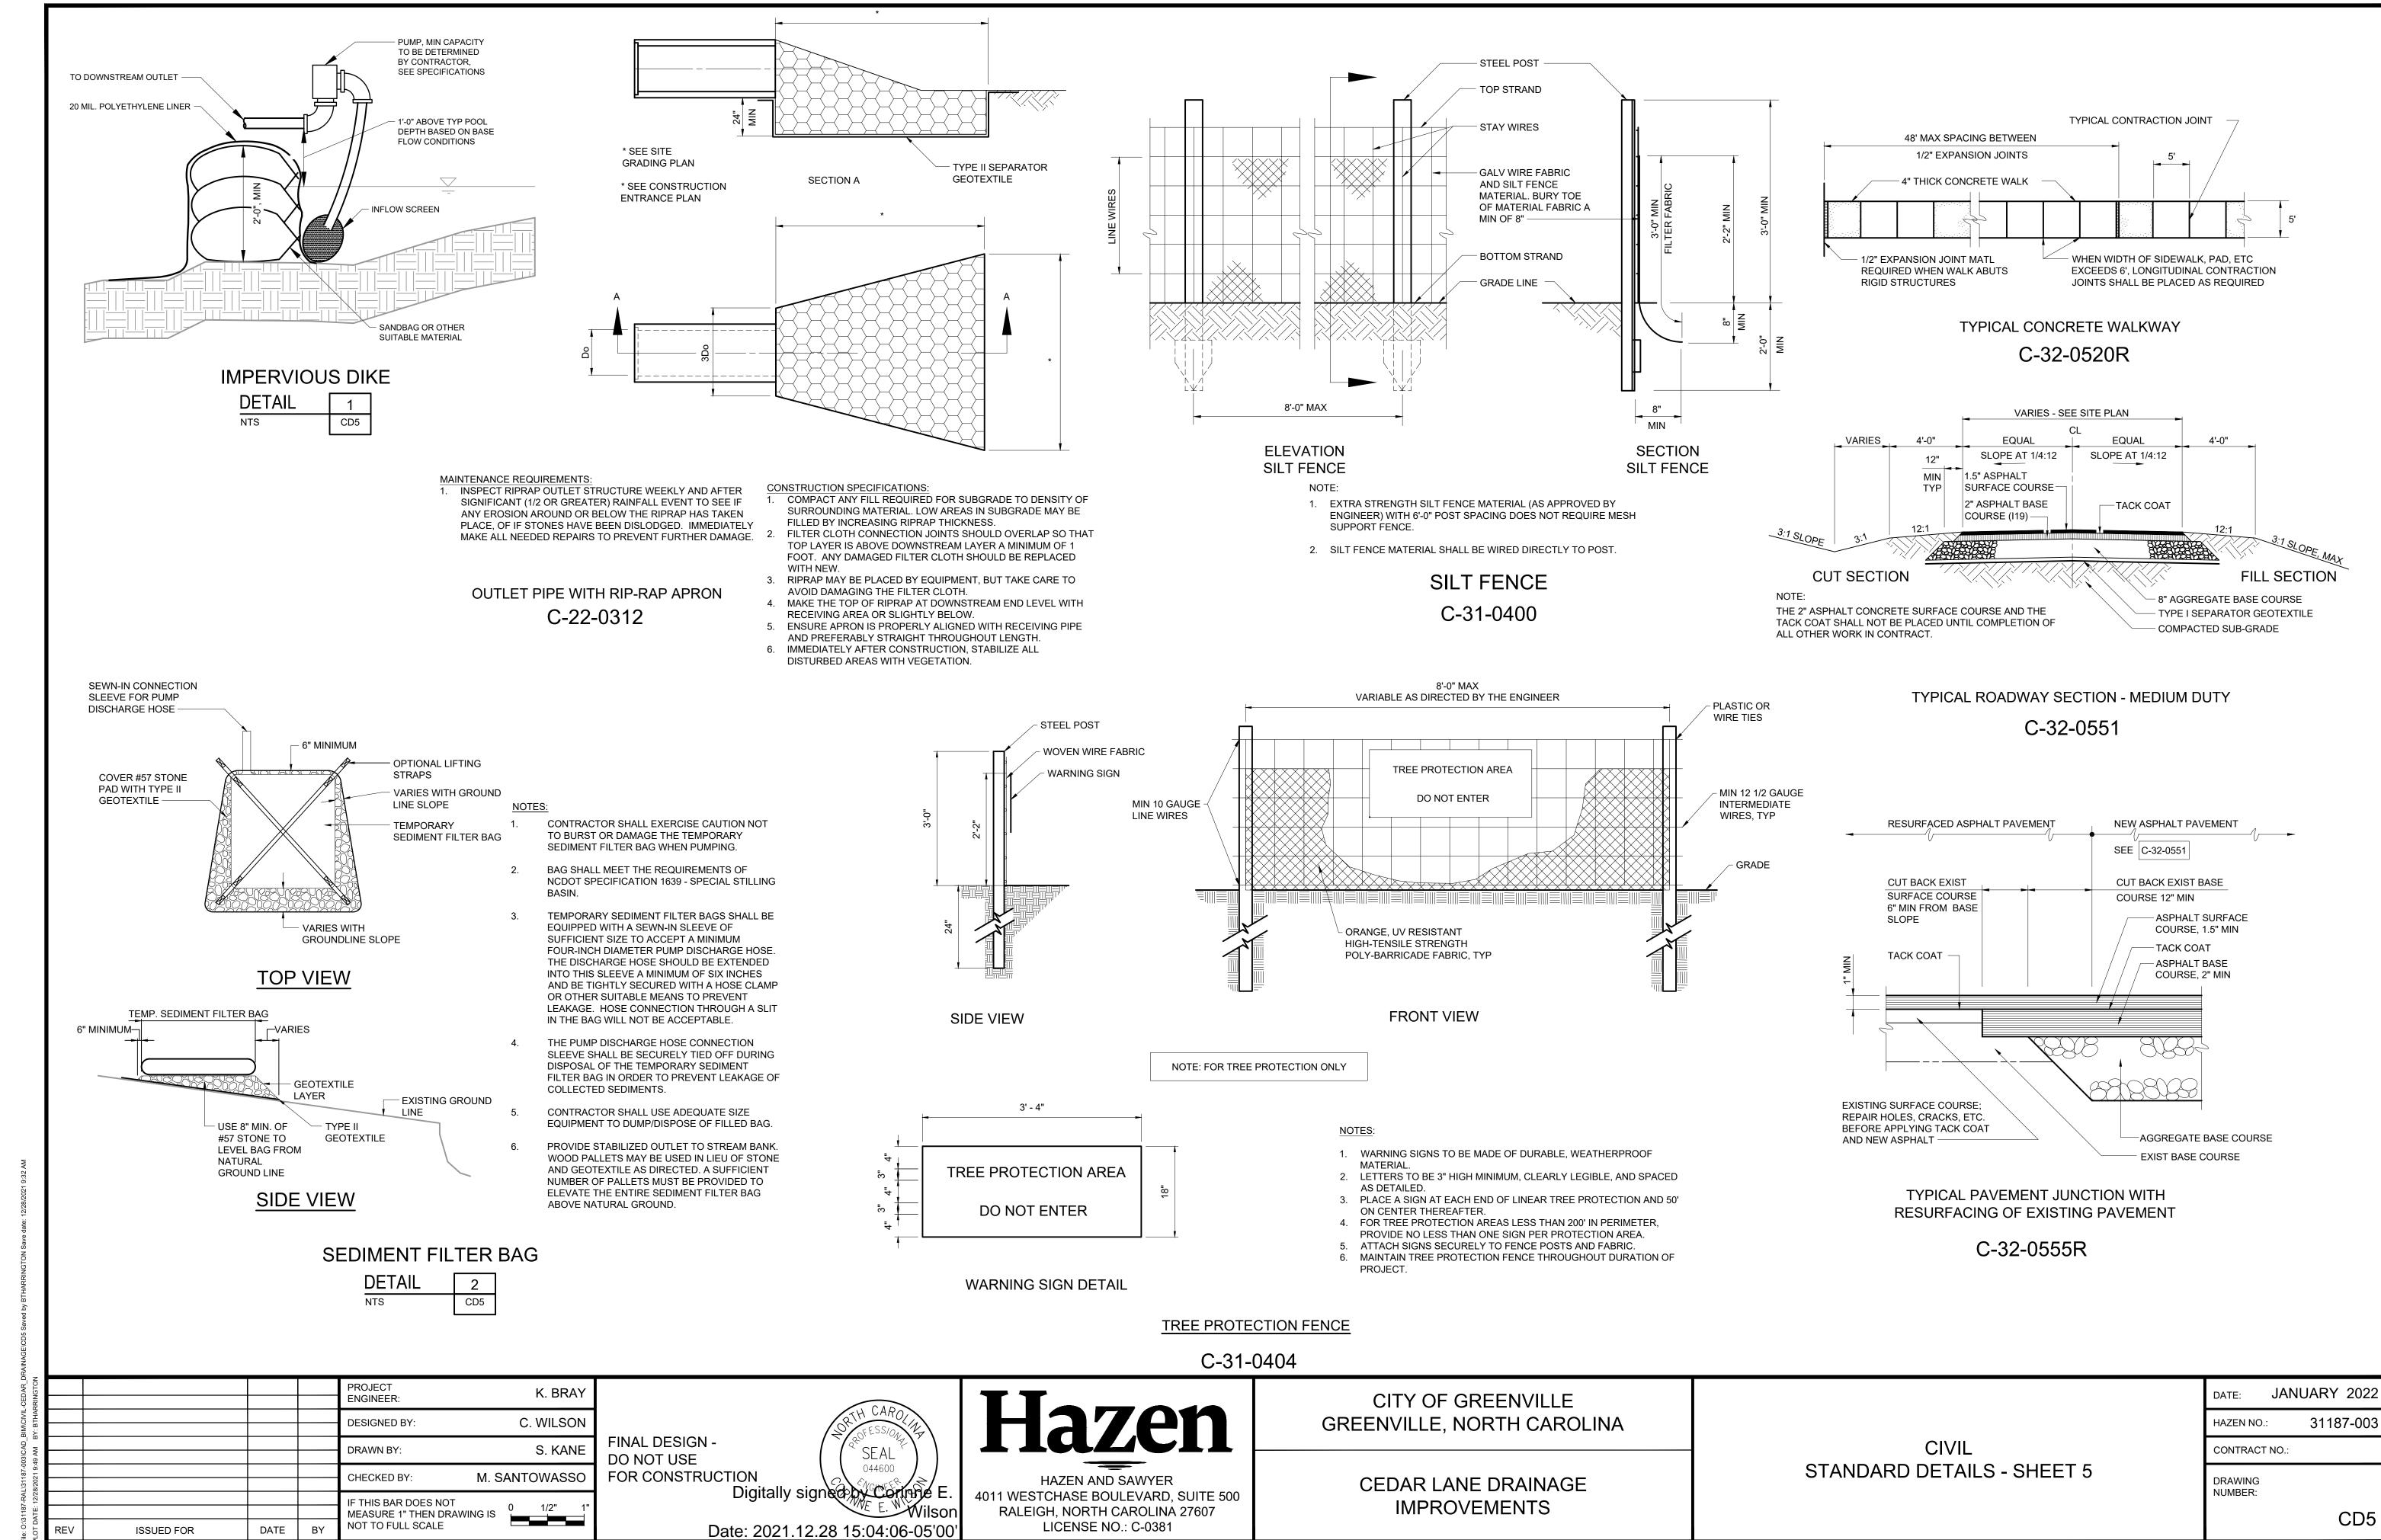


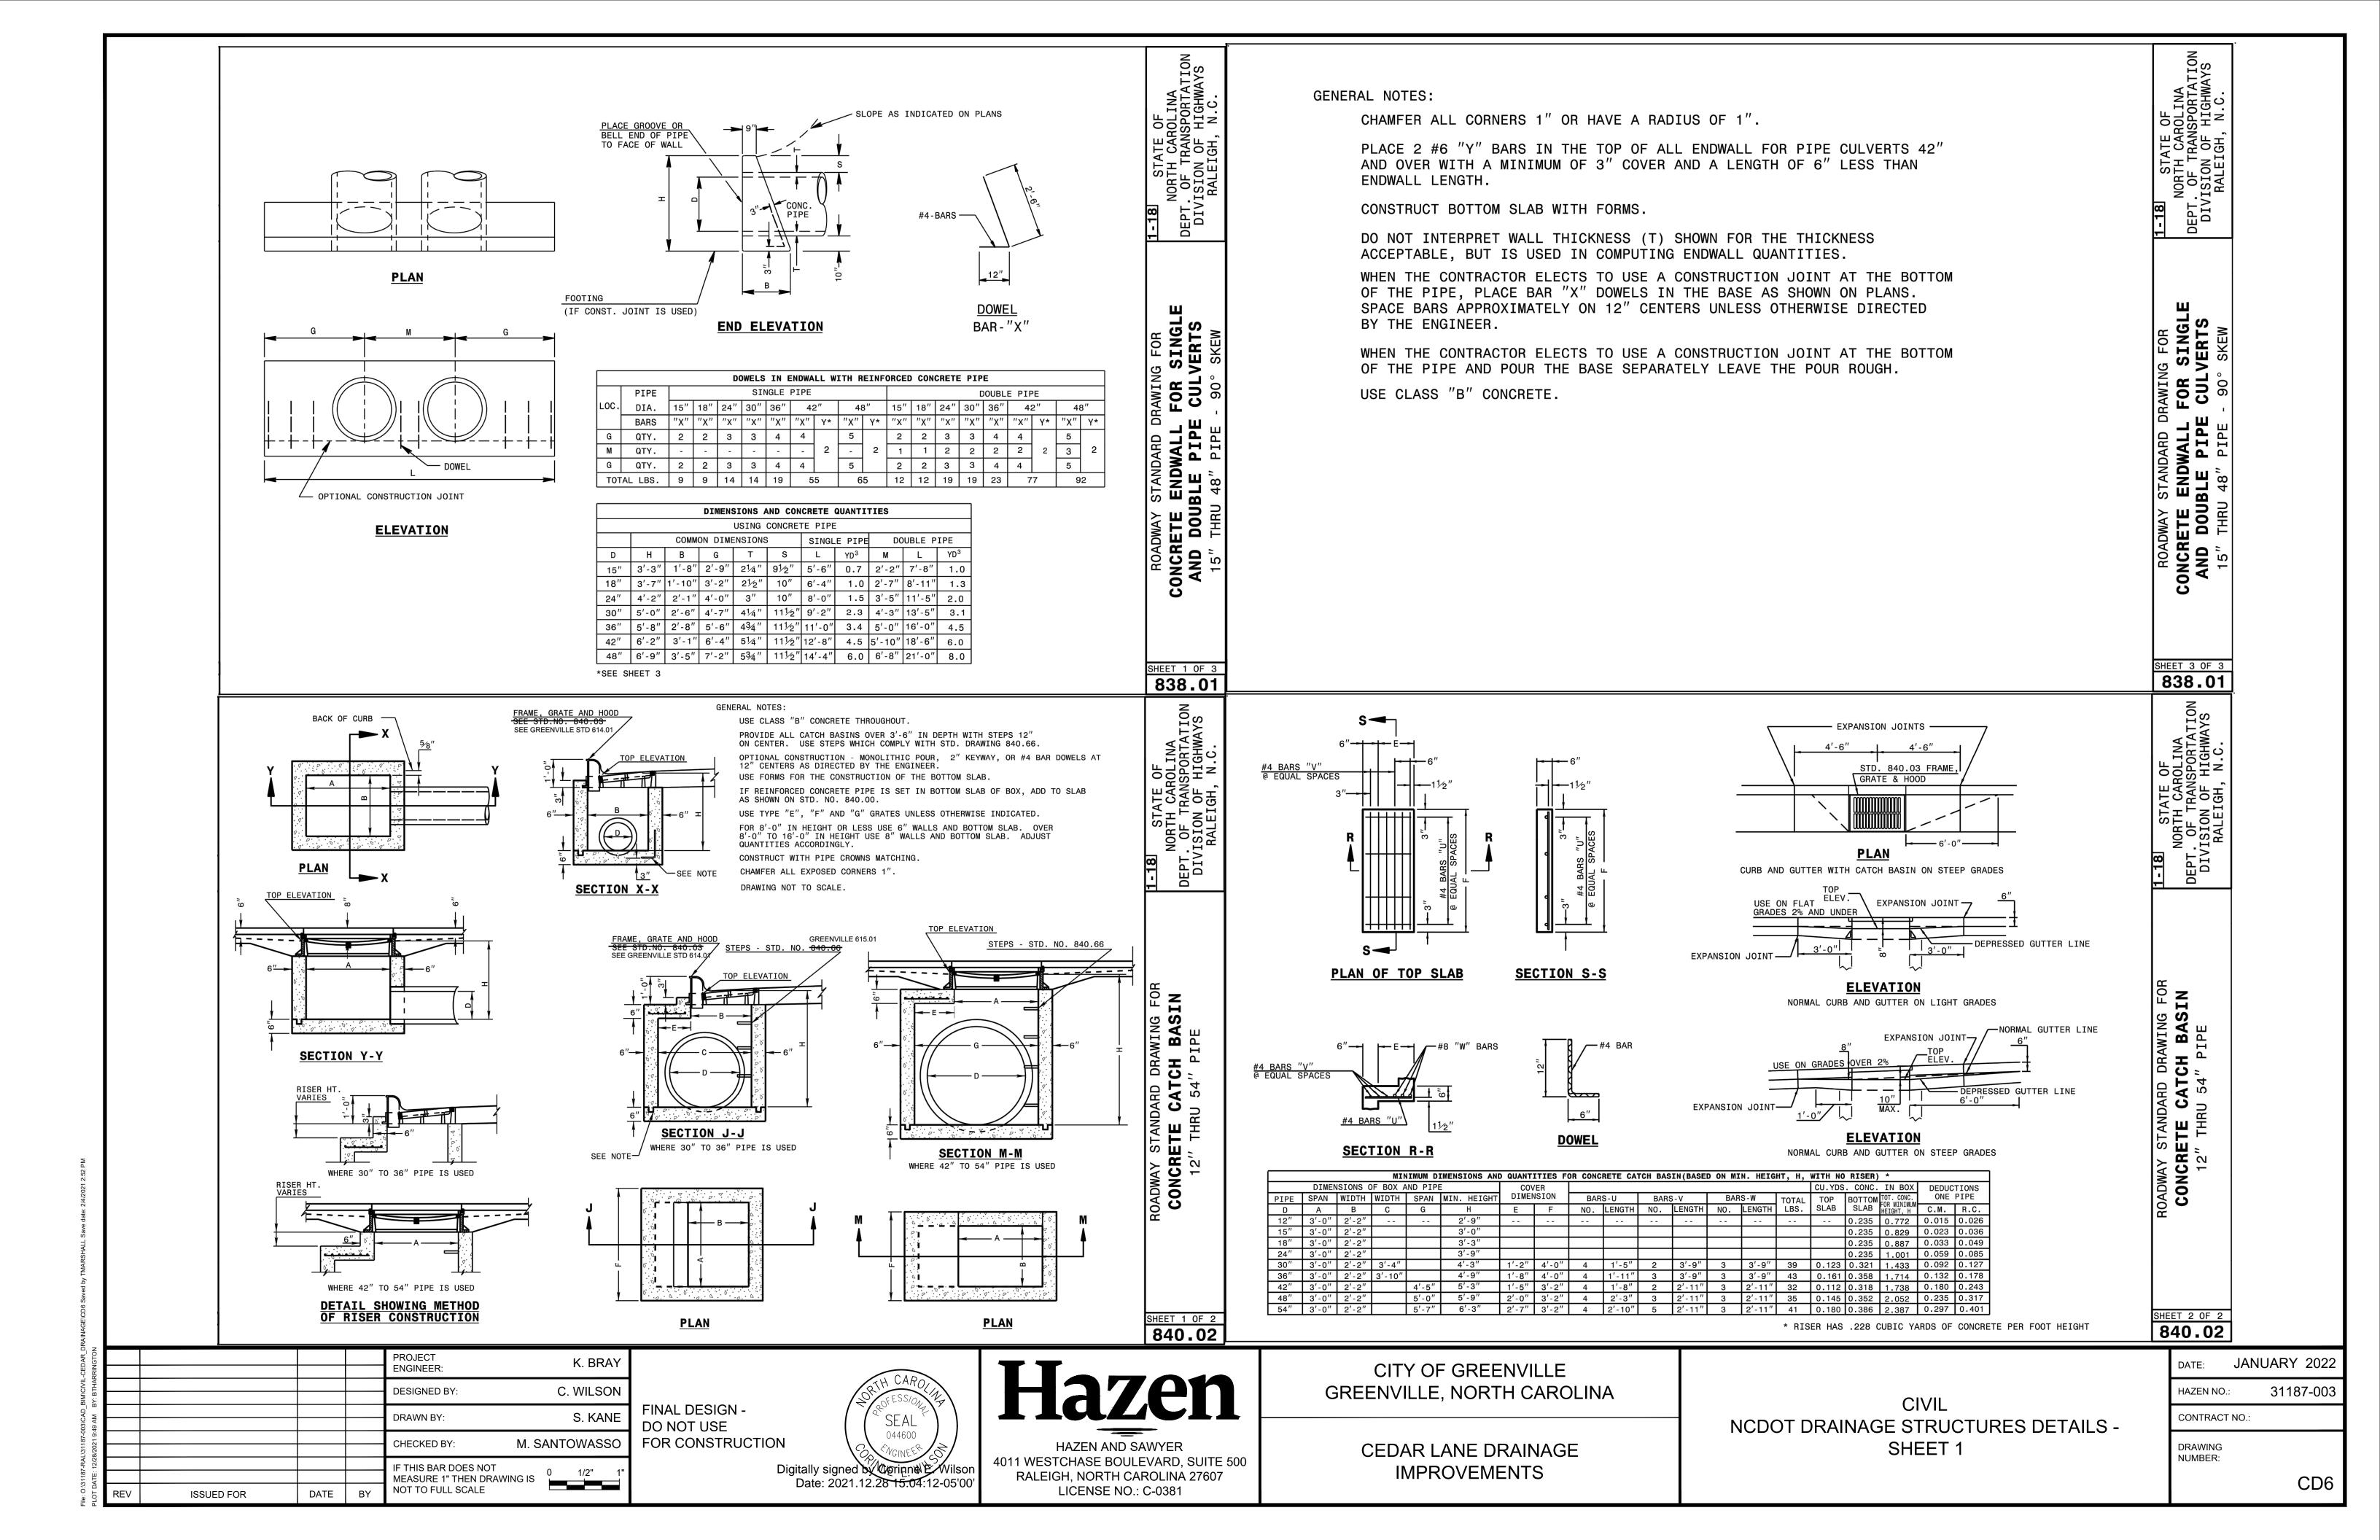


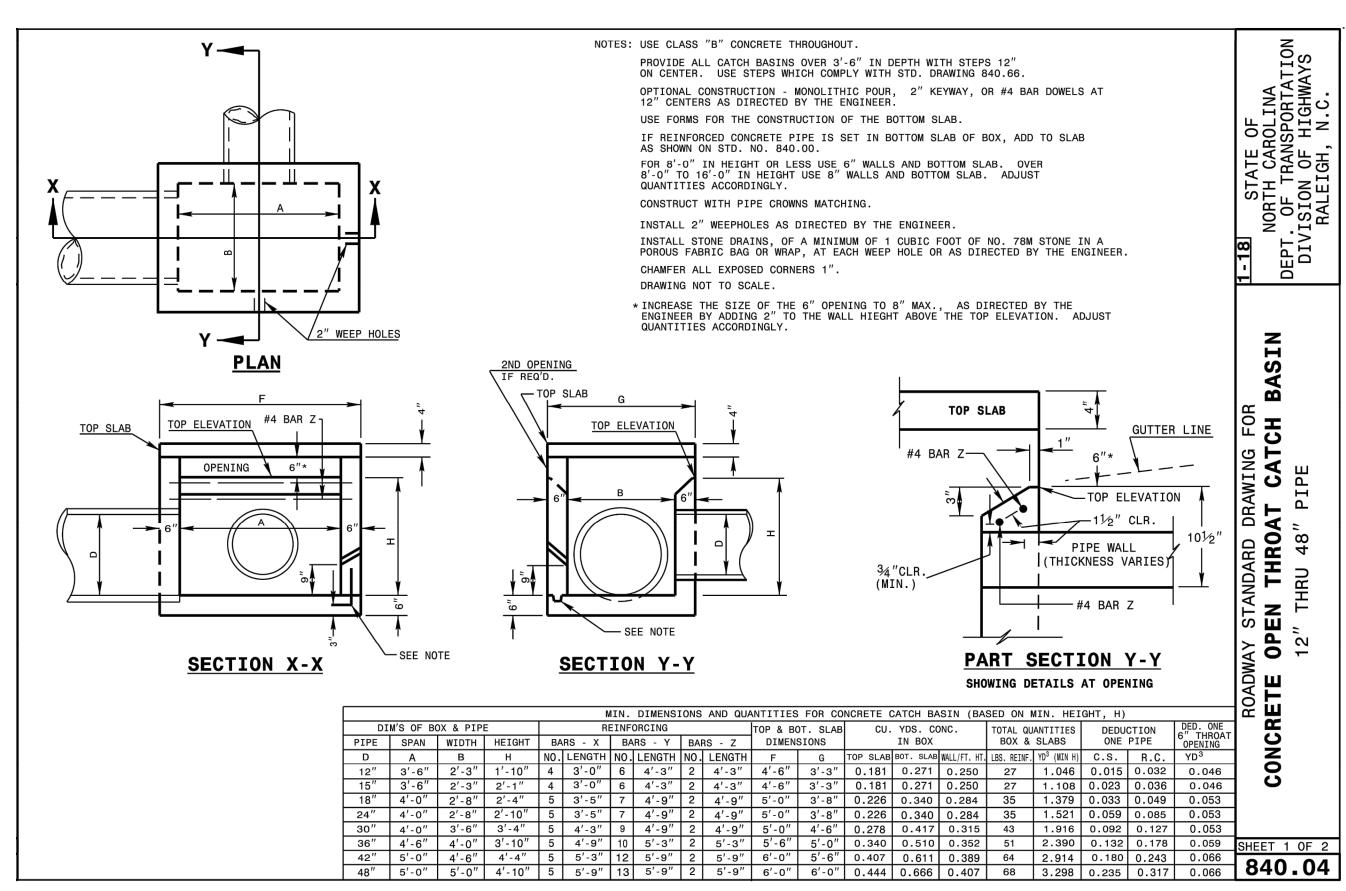


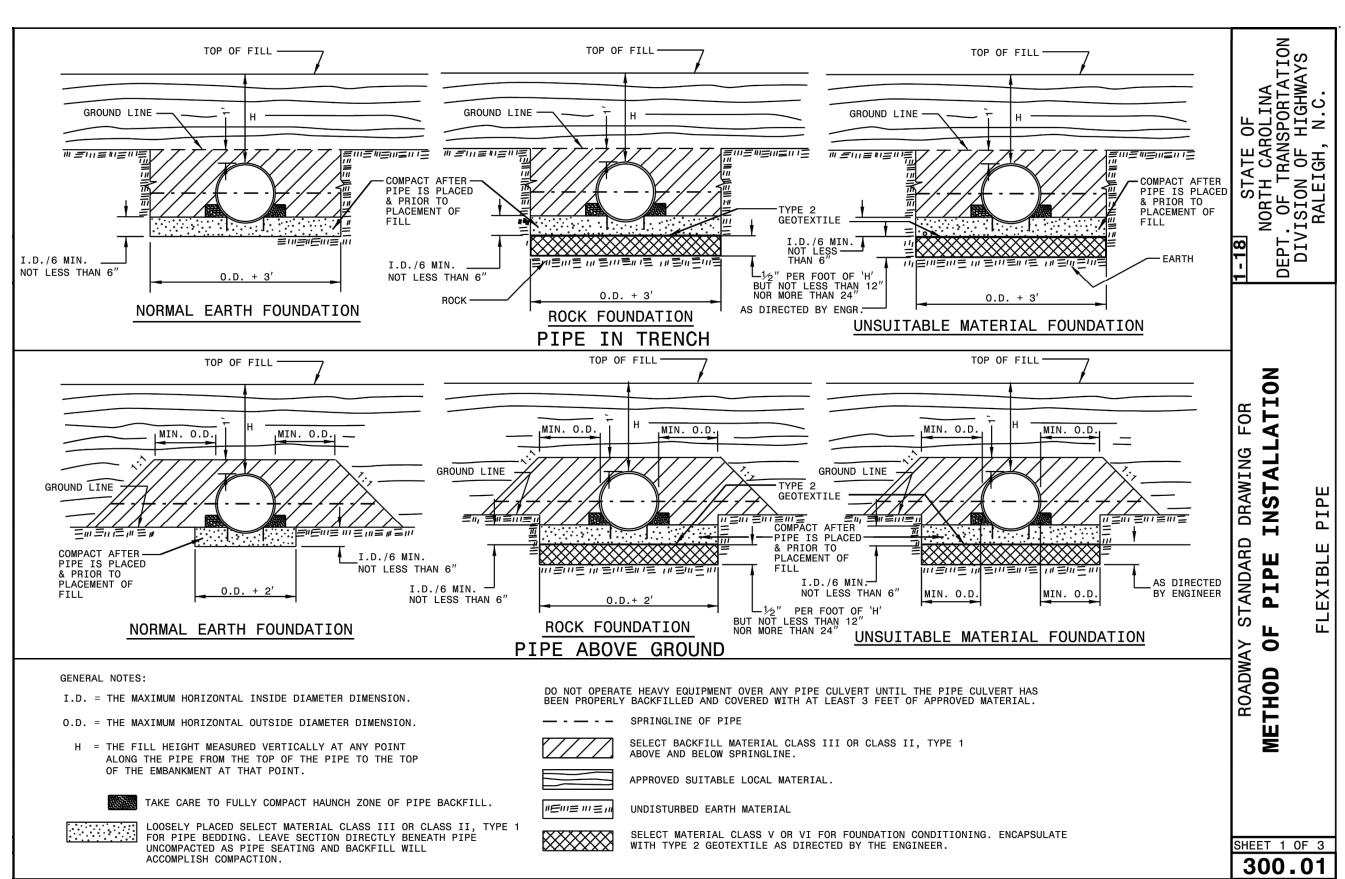

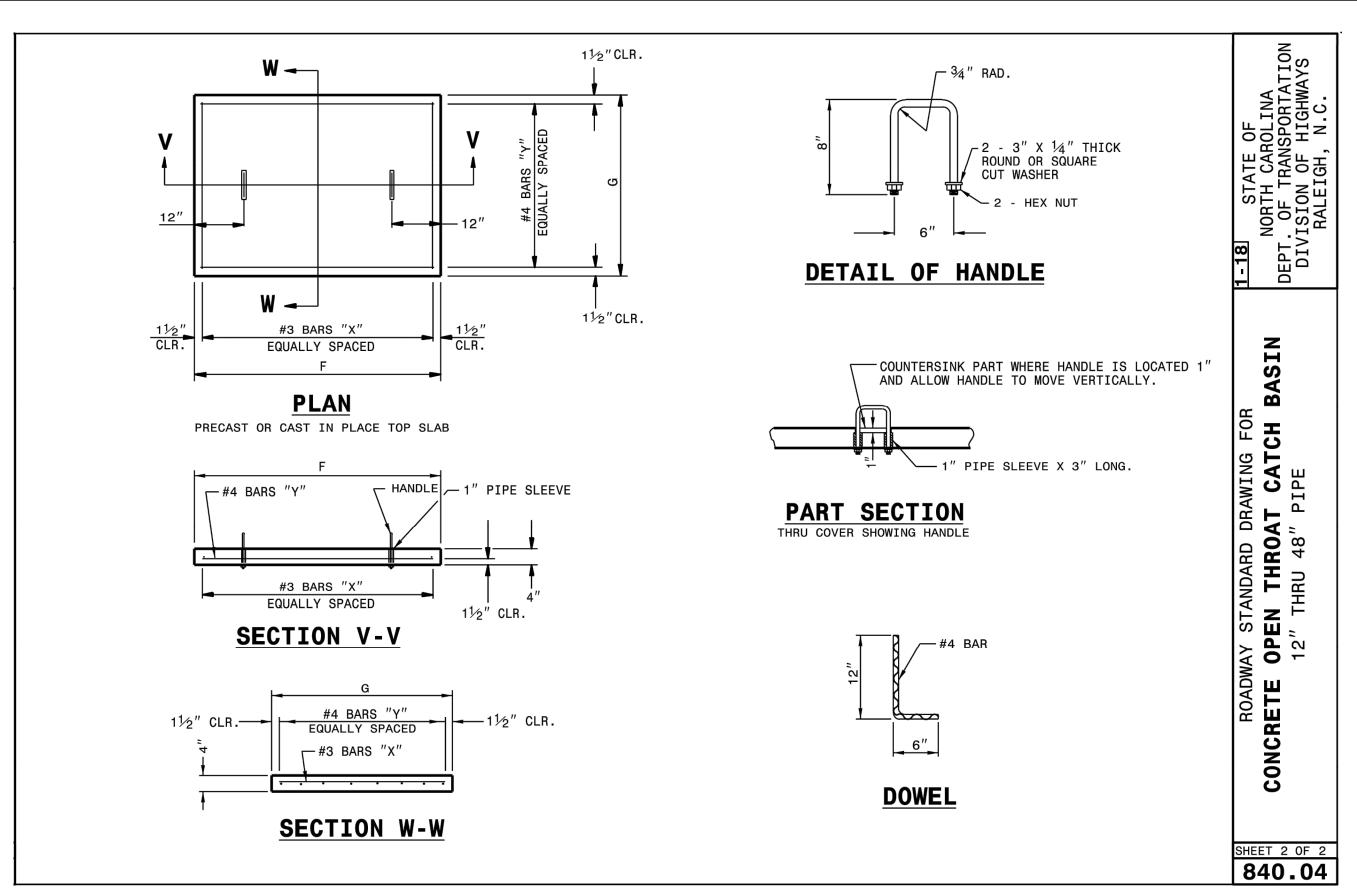

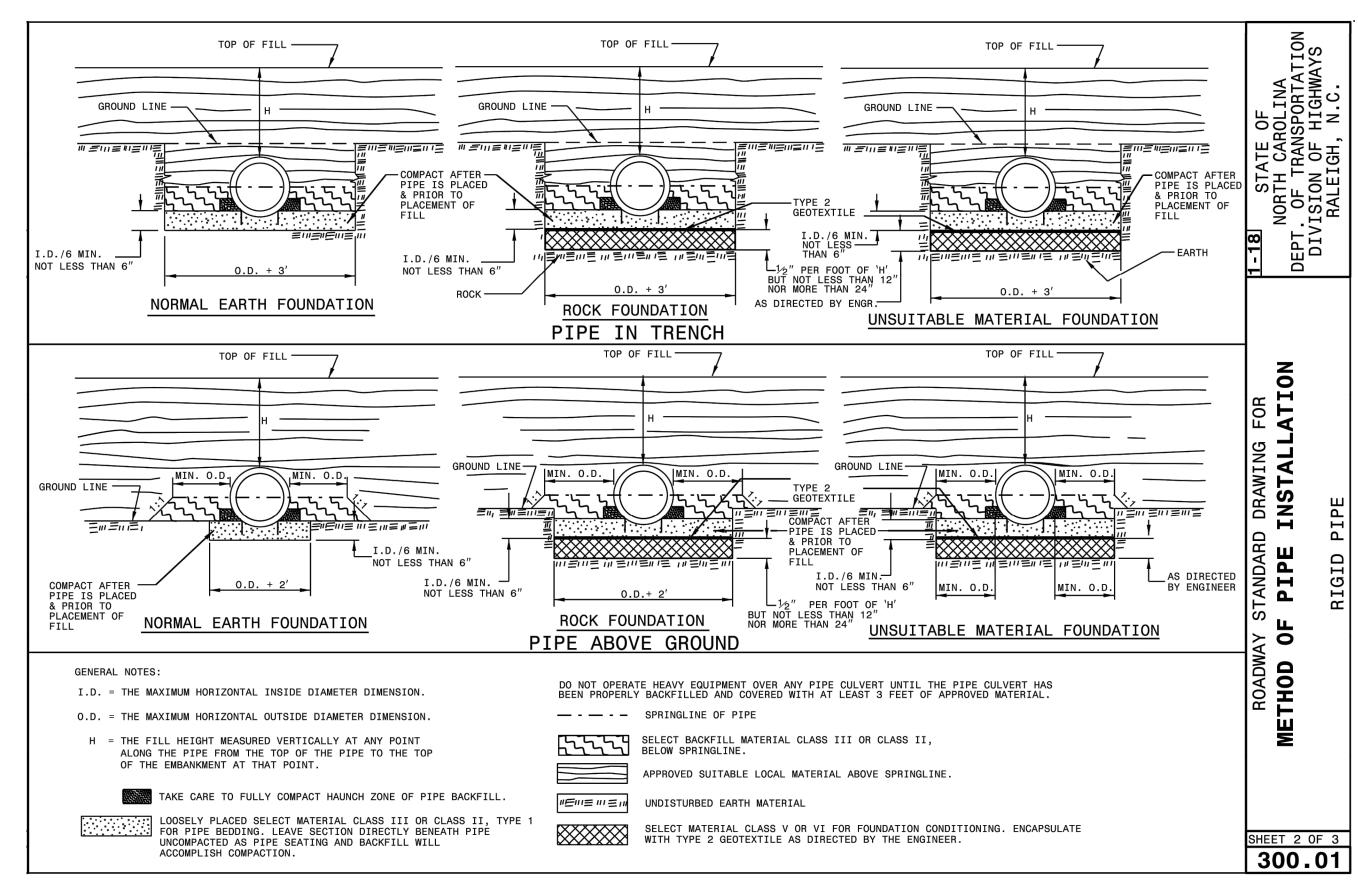

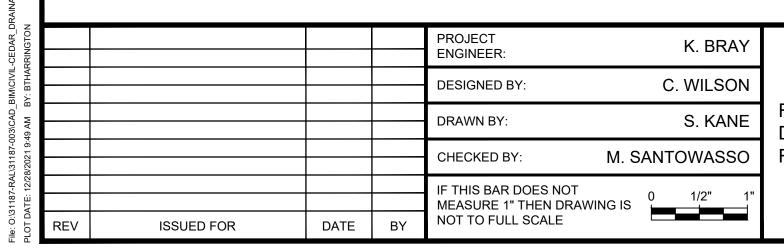

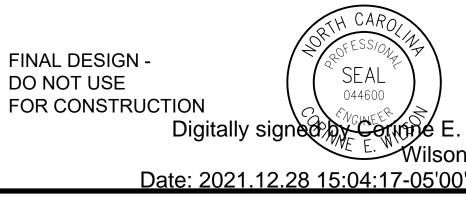

HAZEN AND SAWYER

HAZEN AND SAWYER
4011 WESTCHASE BOULEVARD, SUITE 500
RALEIGH, NORTH CAROLINA 27607
LICENSE NO.: C-0381


CITY OF GREENVILLE GREENVILLE, NORTH CAROLINA

CEDAR LANE DRAINAGE IMPROVEMENTS

CIVIL
NCDOT DRAINAGE STRUCTURES DETAILS SHEET 2

DATE:	JANUARY	2022
HAZEN NO.	: 3118	7-003
CONTRACT	NO.:	
DRAWING NUMBER:		

CD7

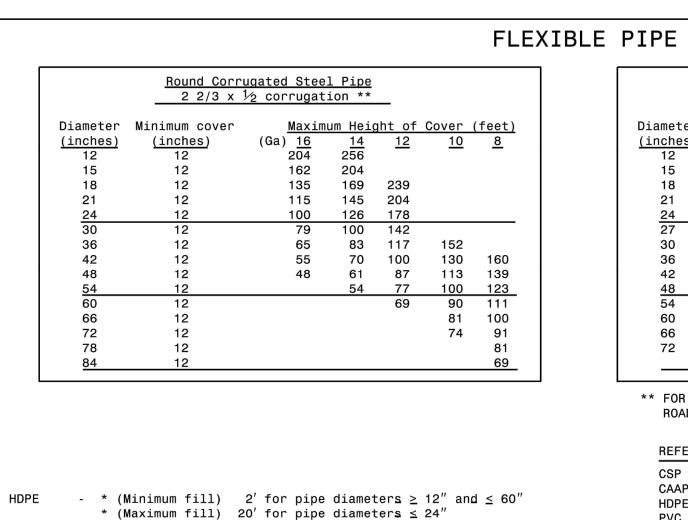

Round Corrugated Aluminum Pipe 2 2/3 x ½ corrugation \*\* Maximum Height of Cover (feet) Diameter Minimum cover (inches) 12 (Ga) <u>16</u> 123 <u>12</u> 218 (inches) <u>14</u> 155 <u>10</u> <u>8</u> 281 344 123 174 224 275 81 102 144 187 228 87 123 160 195 
 108
 139
 171

 95
 123
 151
 60 85 111 136 50 71 92 113 42 60 78 96 50 62 60 72

\*\* FOR DIFFERENT CORRUGATIONS AND ARCH PIPES REFER TO ROADWAY DESIGN MANUAL OR MANUFACTURERS SPECIFICATION.

REFER TO THE FOLLOWING FOR PIPE SPECIFICATIONS

CSP - AASHTO M36 CAAP - AASHTO M196 HDPE - AASHTO M294

PVC - ASTM F949 or AASHTO M304

NOTES: FILL HEIGHTS SHOWN WERE CALCULATED USING AASHTO LRFD BRIDGE DESIGN SPECIFICATIONS

> 1' MINIMUM COVER FOR ALL SIDE DRAIN PIPE IN ACCORDANCE WITH THE STANDARD SPECIFICATIONS

RIGID PIPE

RCP - \* (Minimum fill) 1' for Class IV & CLASS V 2' for Class III & Class II

\* FILL HEIGHT IS MEASURED FROM THE TOP OF THE PIPE

TO THE BOTTOM OF THE PAVEMENT STRUCTURE

\* (Maximum fill) 10' - Class II pipe 20' - Class III pipe

- \* (Minimum fill) 2' for pipe diameters  $\geq$  12" and  $\leq$  36"

\* (Maximum fill) 30' for pipe diameters  $\geq$  12" and  $\leq$  36"

30' - Class IV pipe 40' - Class V pipe

17' for pipe diameters  $\geq$  30" and  $\leq$  60"

(For fills > 40' & < 80' use LRFD Direct Design Method)

\* FILL HEIGHT IS MEASURED FROM THE TOP OF THE PIPE TO THE BOTTOM OF THE PAVEMENT STRUCTURE

REFER TO THE FOLLOWING FOR PIPE SPECIFICATIONS

RCP - AASHTO M170

NOTES: FILL HEIGHTS SHOWN WERE CALCULATED USING AASHTO LRFD BRIDGE DESIGN SPECIFICATIONS

> 1' MINIMUM COVER FOR ALL SIDE DRAIN PIPE IN ACCORDANCE WITH THE STANDARD SPECIFICATIONS

SHEET 3 OF 3 300.01

1-18 STATE OF
NORTH CAROLINA
DEPT. OF TRANSPORTATION
DIVISION OF HIGHWAYS
RALEIGH, N.C.

DRAWING FOR INSTALLATION

TANDARI PIPE

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ZII 0 . I 0					DESIGNED BY: C. WILSON	
NIC OC					DRAWN BY: S. KANE	] F
0/2021 9.1					CHECKED BY: M. SANTOWASSO	F
71 - 12/2					IF THIS BAR DOES NOT  MEASURE 1" THEN DRAWING IS  0 1/2" 1"	· ]
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FINAL DESIGN -DO NOT USE FOR CONSTRUCTION

Digitally signed by Wring Wilson Date: 2021.12.28 15:04:23-05'00'



LICENSE NO.: C-0381


CITY OF GREENVILLE GREENVILLE, NORTH CAROLINA

CIVIL NCDOT DRAINAGE STRUCTURES DETAILS -SHEET 3


JANUARY 2022 31187-003 HAZEN NO.: CONTRACT NO.: DRAWING NUMBER:

CD8

CEDAR LANE DRAINAGE **IMPROVEMENTS** 

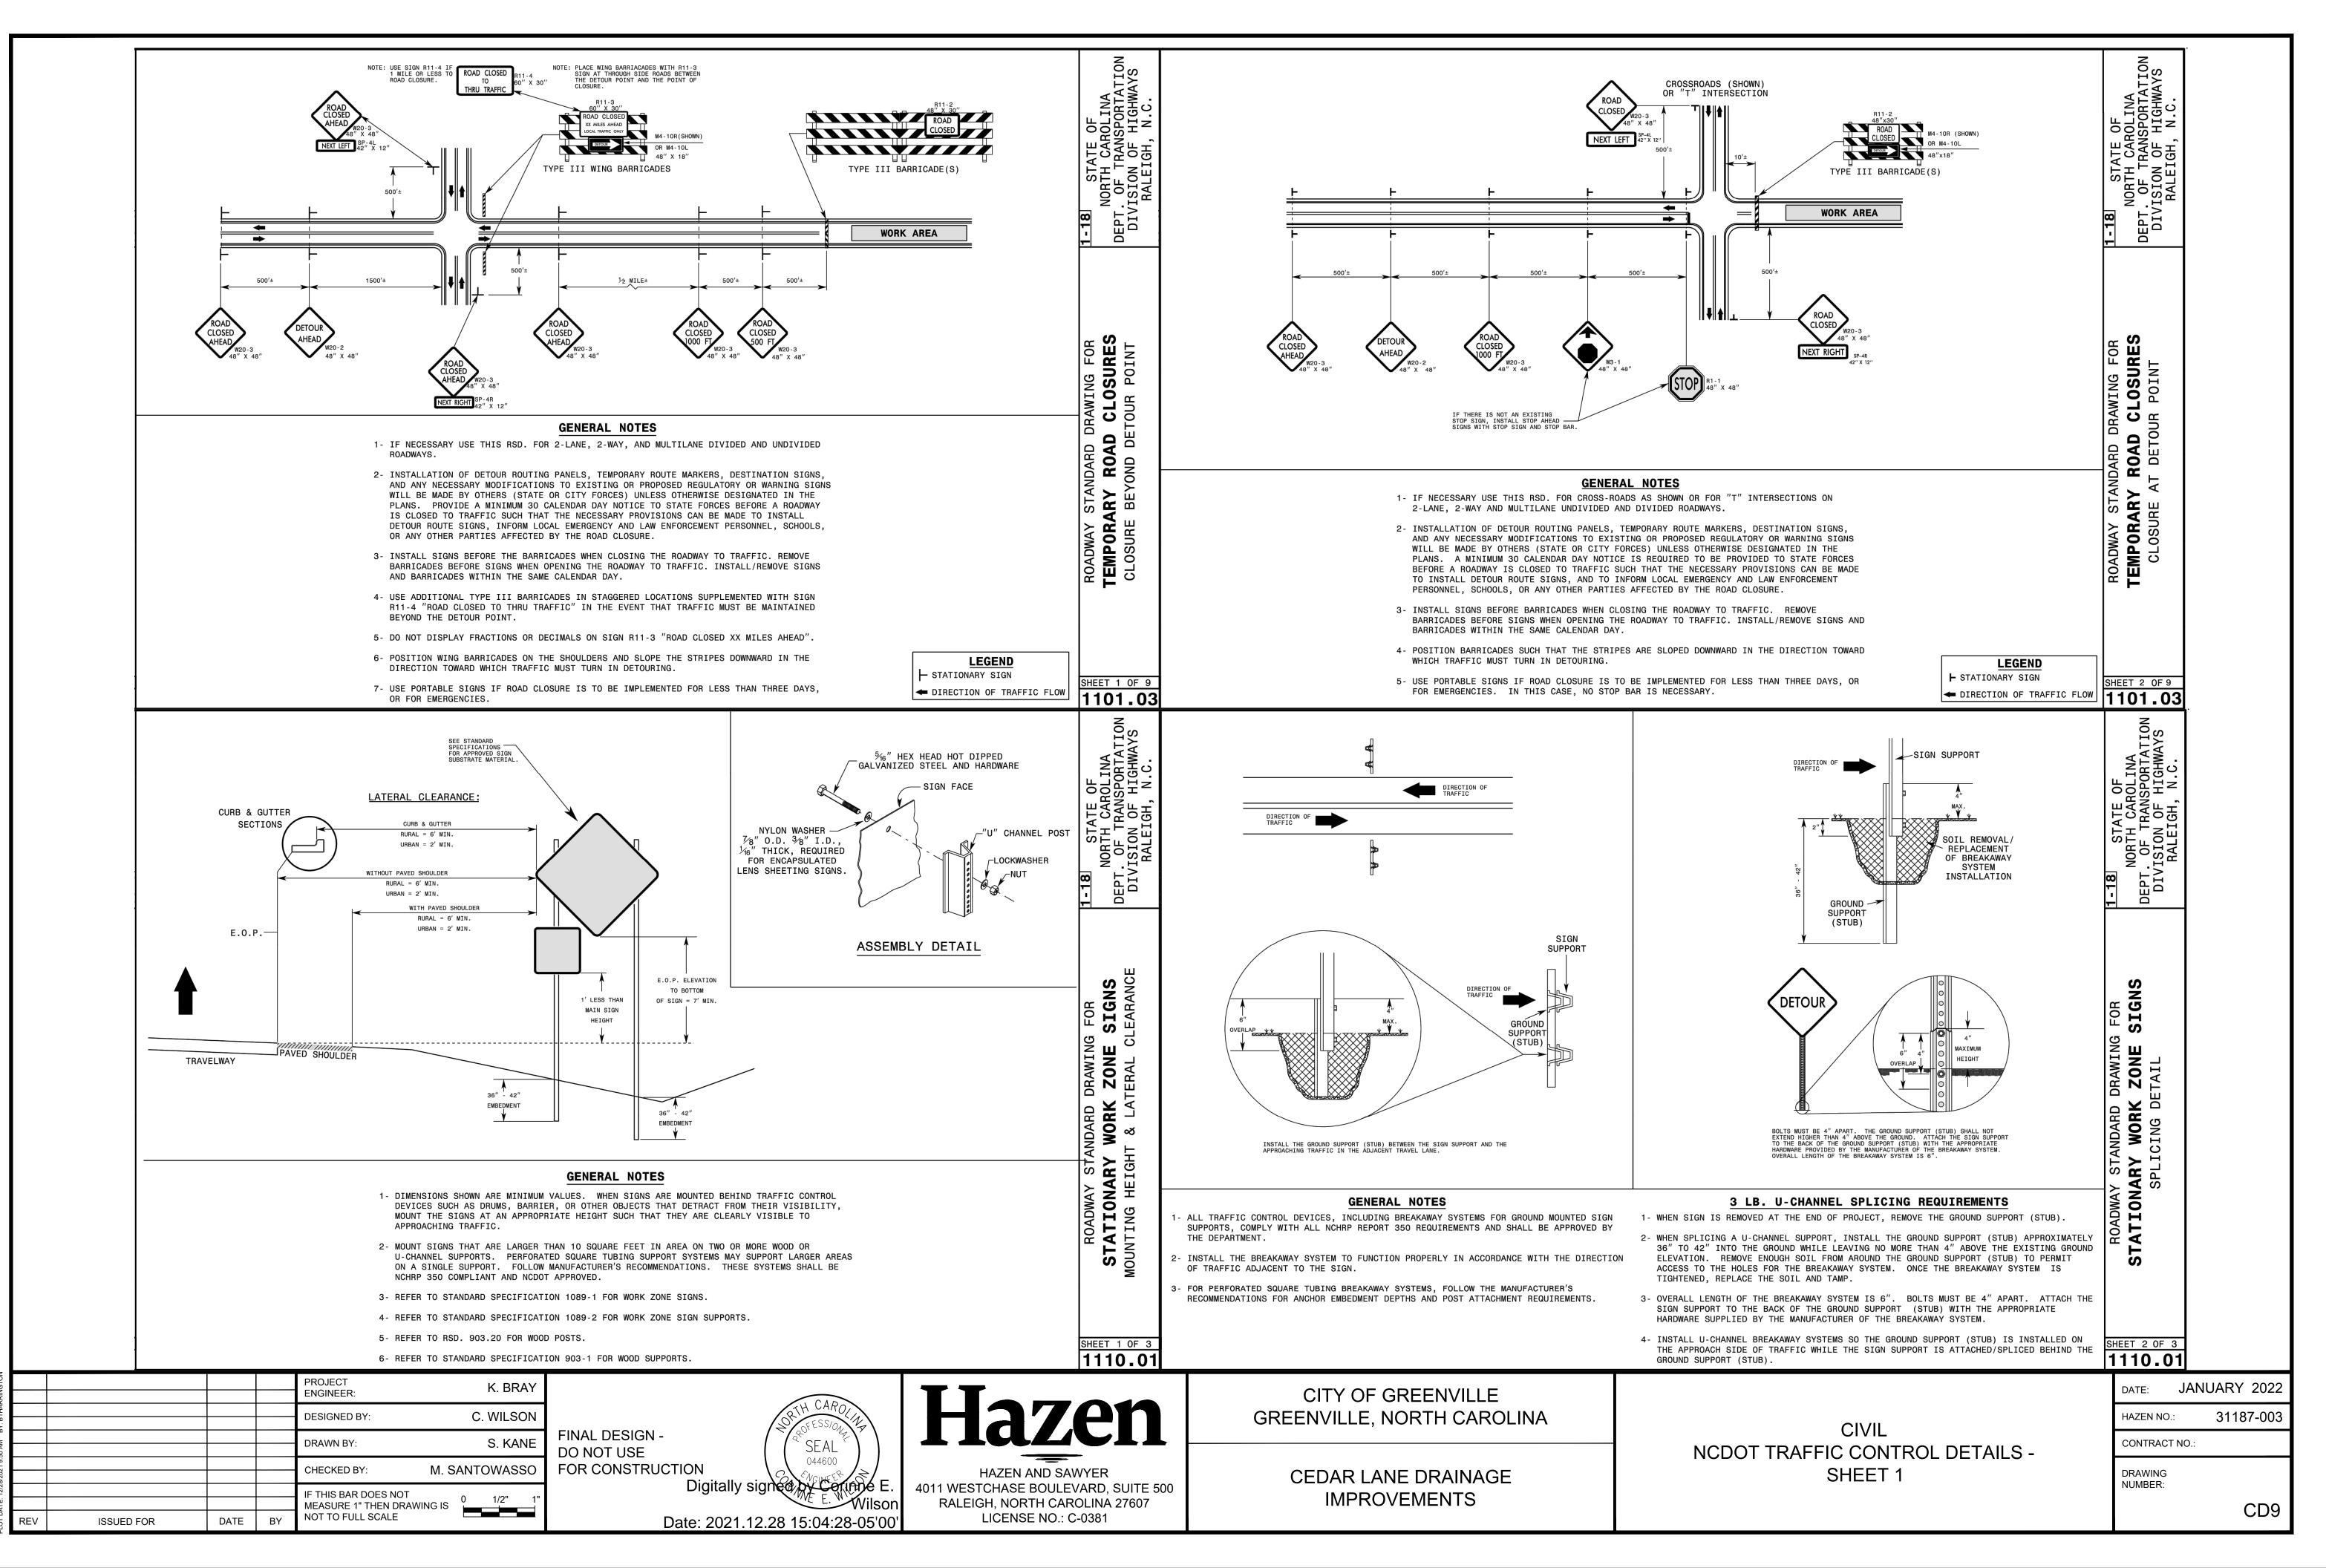

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LICENSE NO.: C-0381

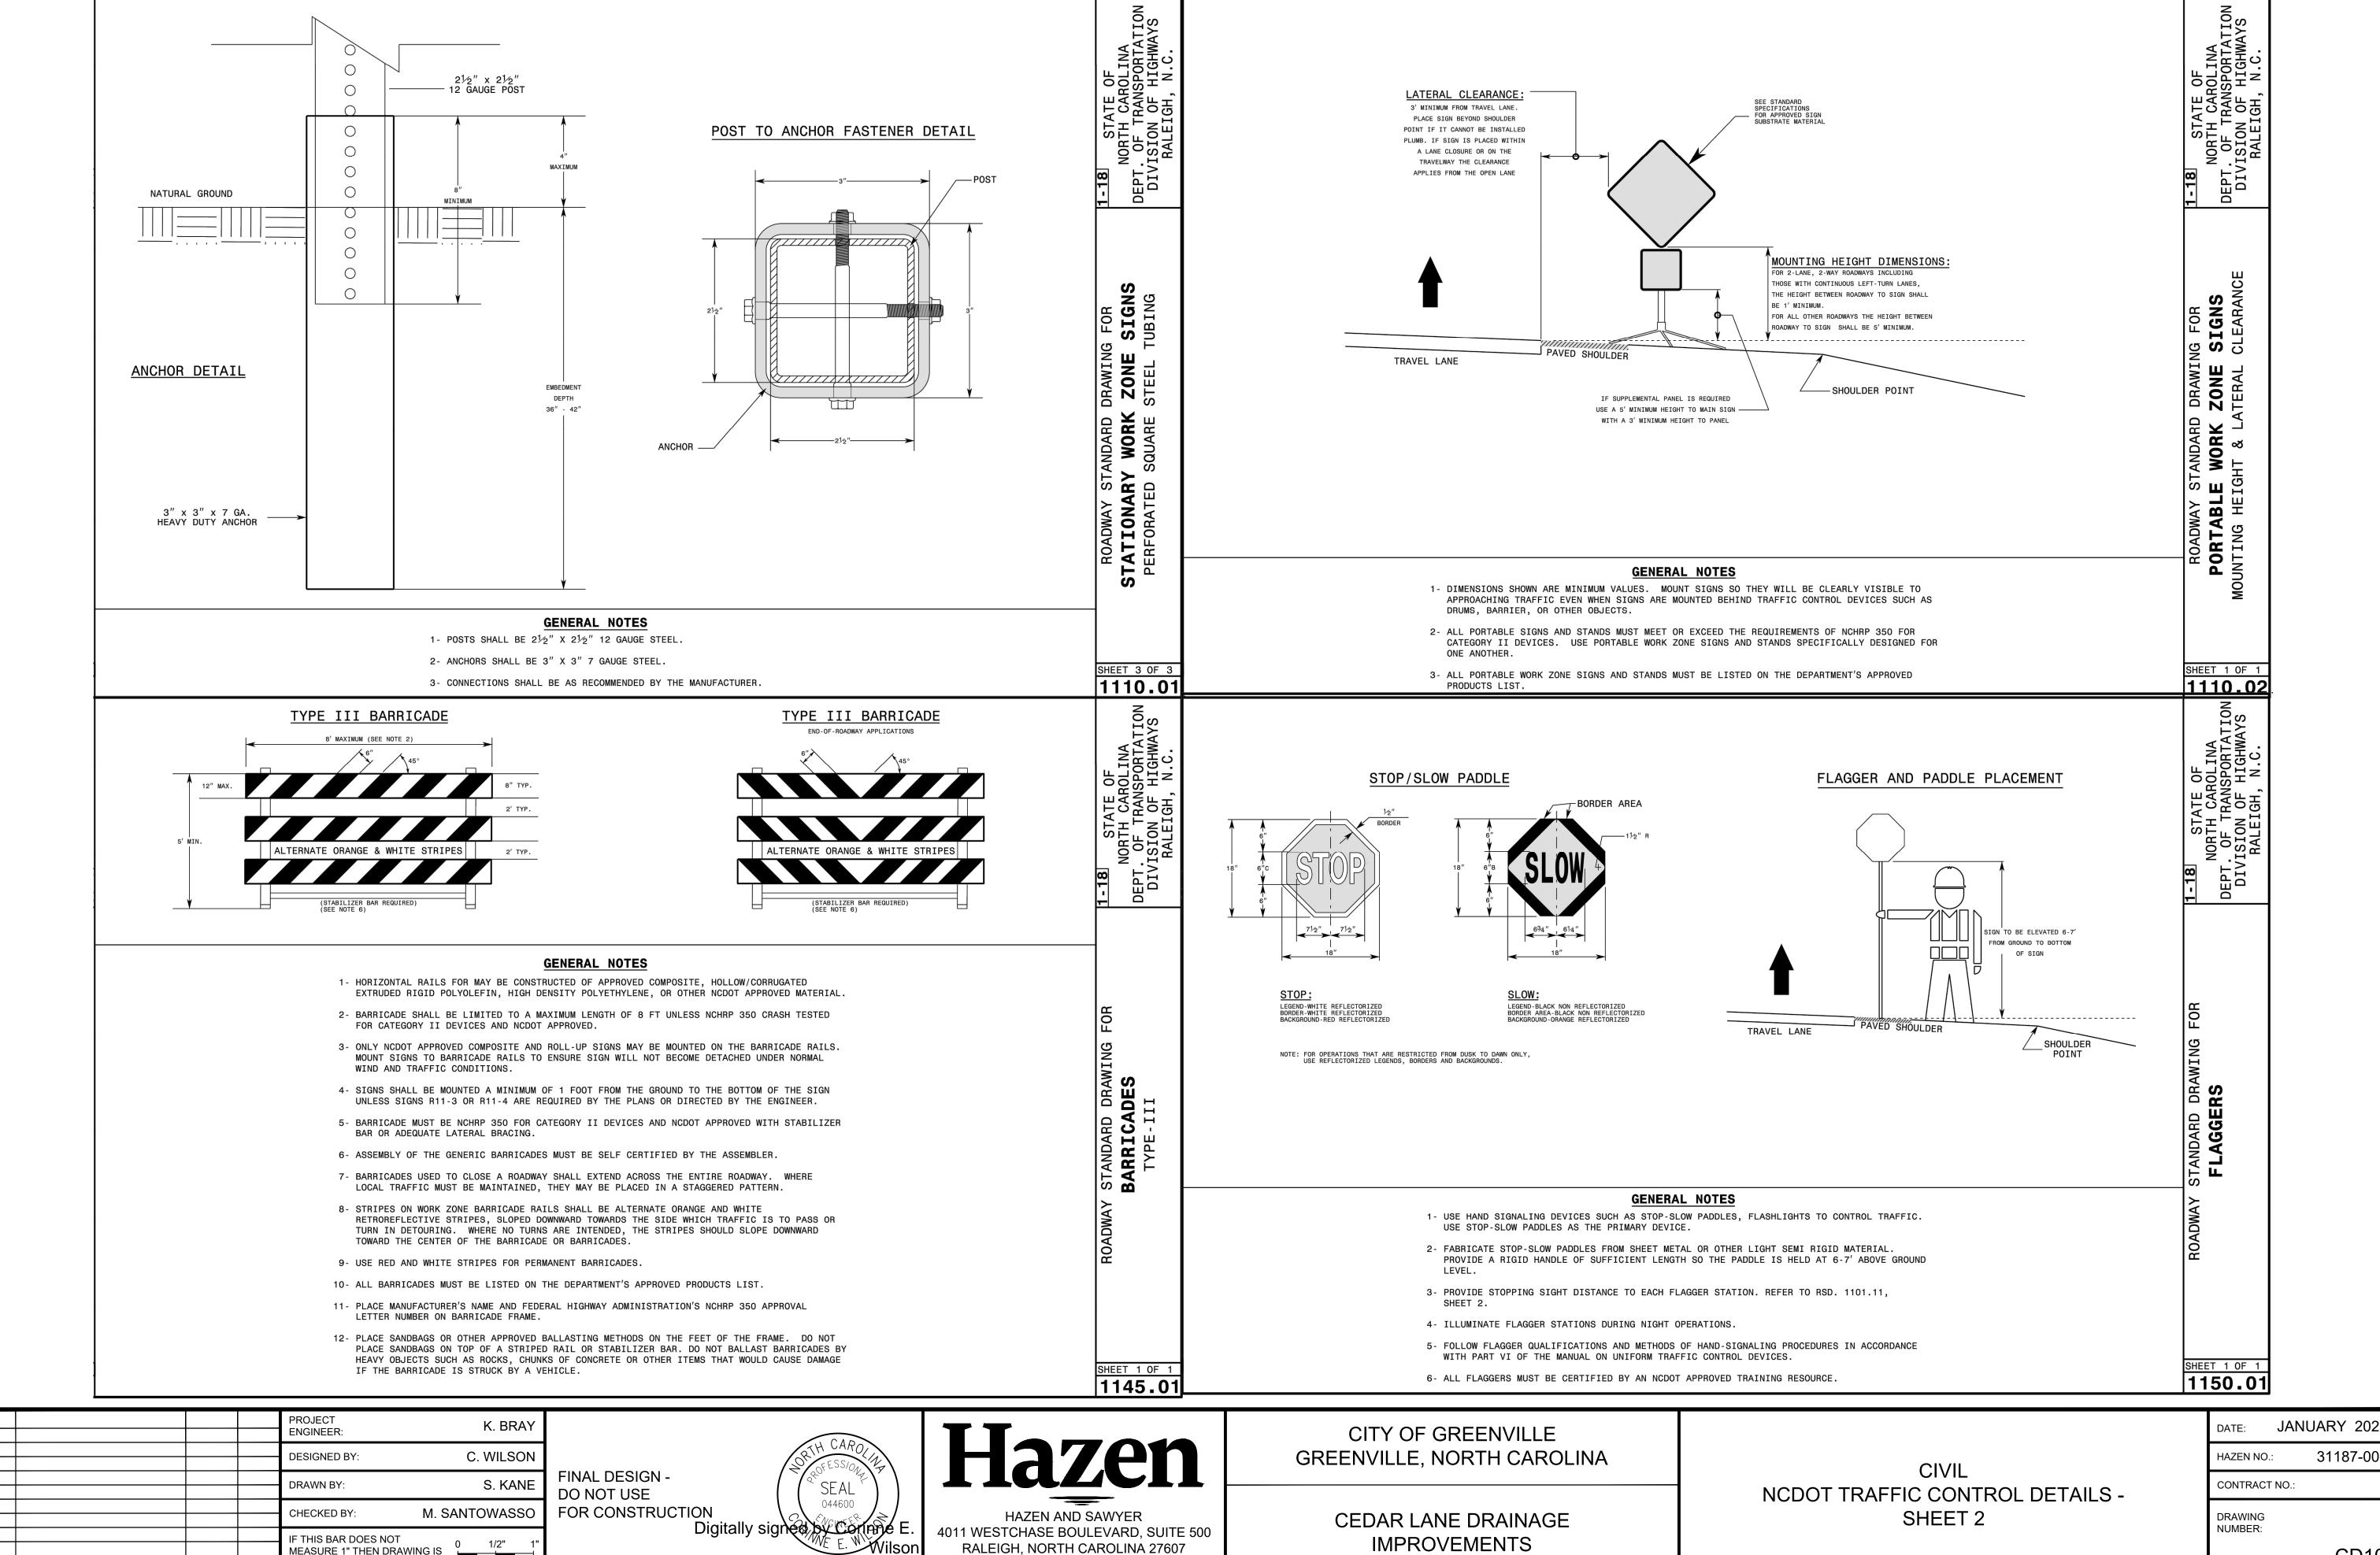1/2" MEASURE 1" THEN DRAWING IS NOT TO FULL SCALE ISSUED FOR

Date: 2021.12.28 15:04:33-05'00

**IMPROVEMENTS** 

DATE:	JANUARY 2022
HAZEN NO.:	31187-003
CONTRACT	NO.:

CD10